



Rev.	Date	By	Check	Details	Appr.
P01	22/06/21	DRM	AC	First Issue.	PGK
P02	06/12/21	MKP	AC	Layout amended	PGK
P03	15/02/23	JPS	AC	Layout amended	PGK

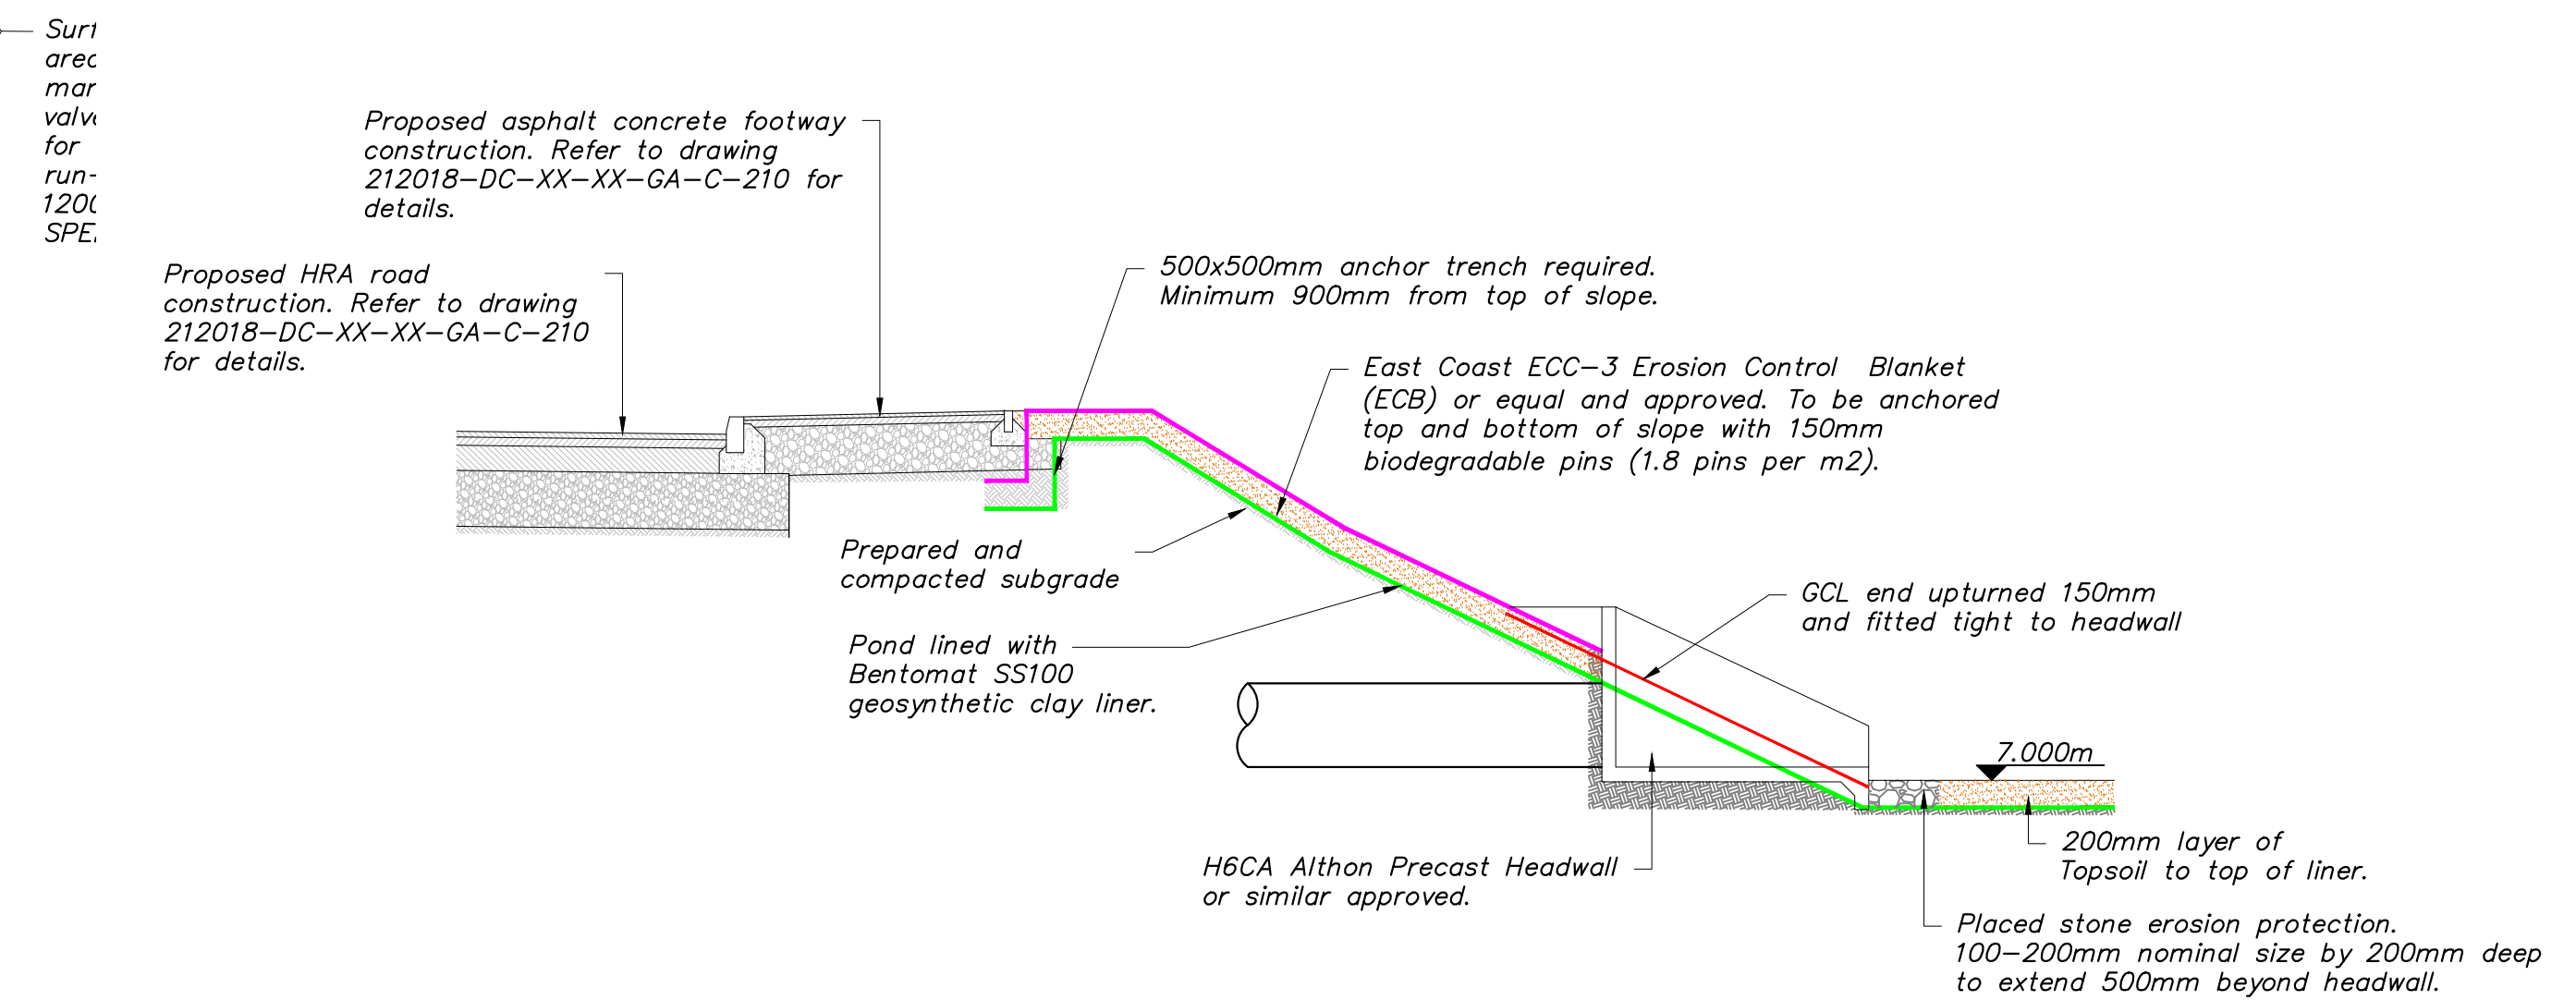


Headwall Construction Detail
1:50

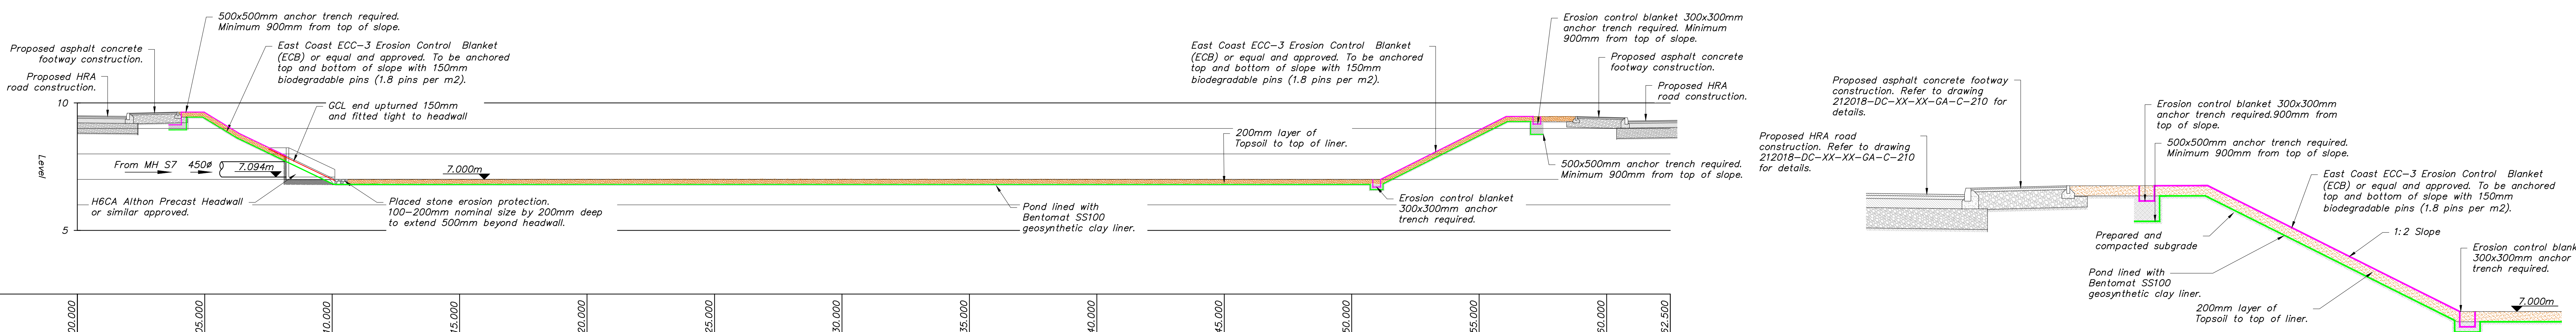

Pond Embankment Construction Detail
1:50


Chainage	00.000	05.000	10.000	15.000	20.000	25.000	30.000	35.000	40.000	45.000	50.000	55.000	60.000	62.500
Existing Levels	9.000	9.000	9.000	9.000	9.000	9.000	9.000	9.000	9.000	9.000	9.000	9.000	9.000	9.000
Proposed Levels	9.487	9.223	7.054	7.000	7.000	7.000	7.000	7.000	7.000	7.000	7.000	8.836	9.436	9.317

Section 1-1 Scale 1:100
Scale: H 1:100, V 1:100, Datum: 5.000

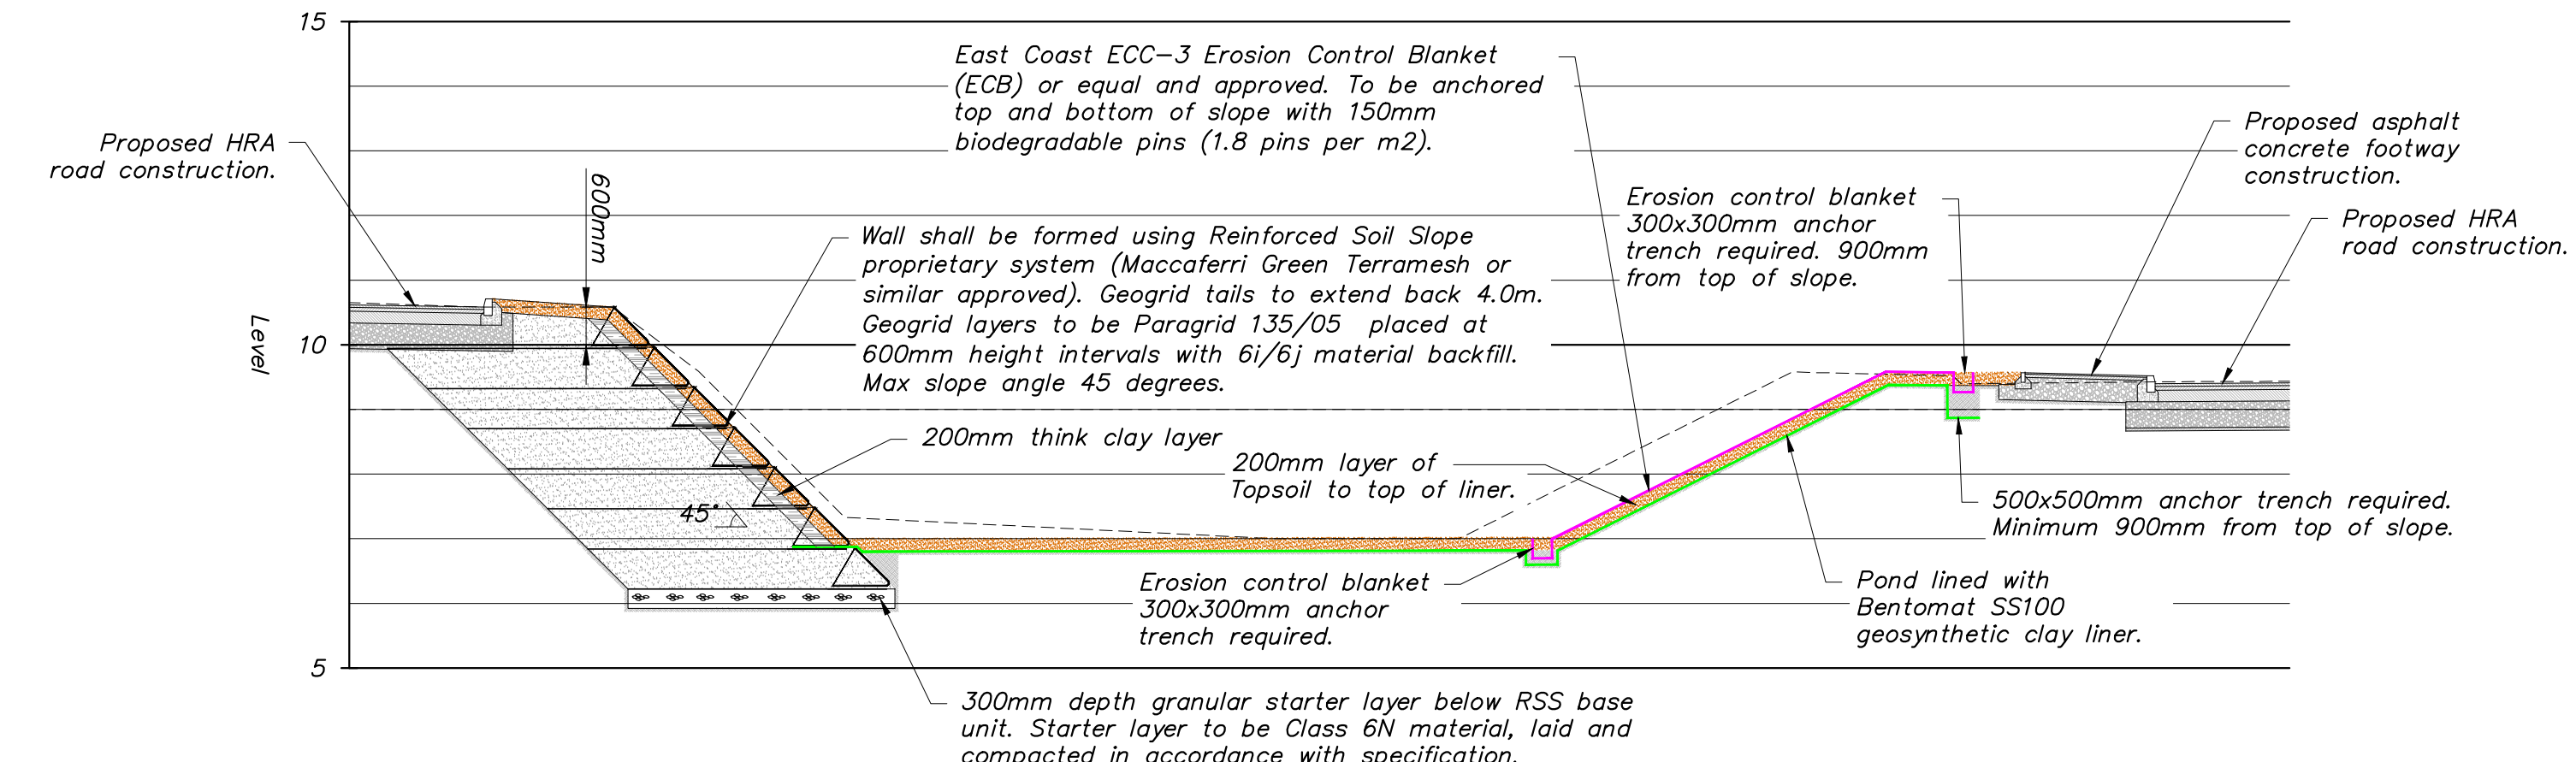

Chainage	00.000	05.000	10.000	15.000	20.000	25.000	30.000
Existing Levels	9.000	9.000	9.000	9.000	9.000	9.000	9.000
Proposed Levels	10.651	9.889	7.214	7.000	8.423	9.397	9.436

Section 2-2 Scale 1:100
Scale: H 1:100, V 1:100, Datum: 5.000

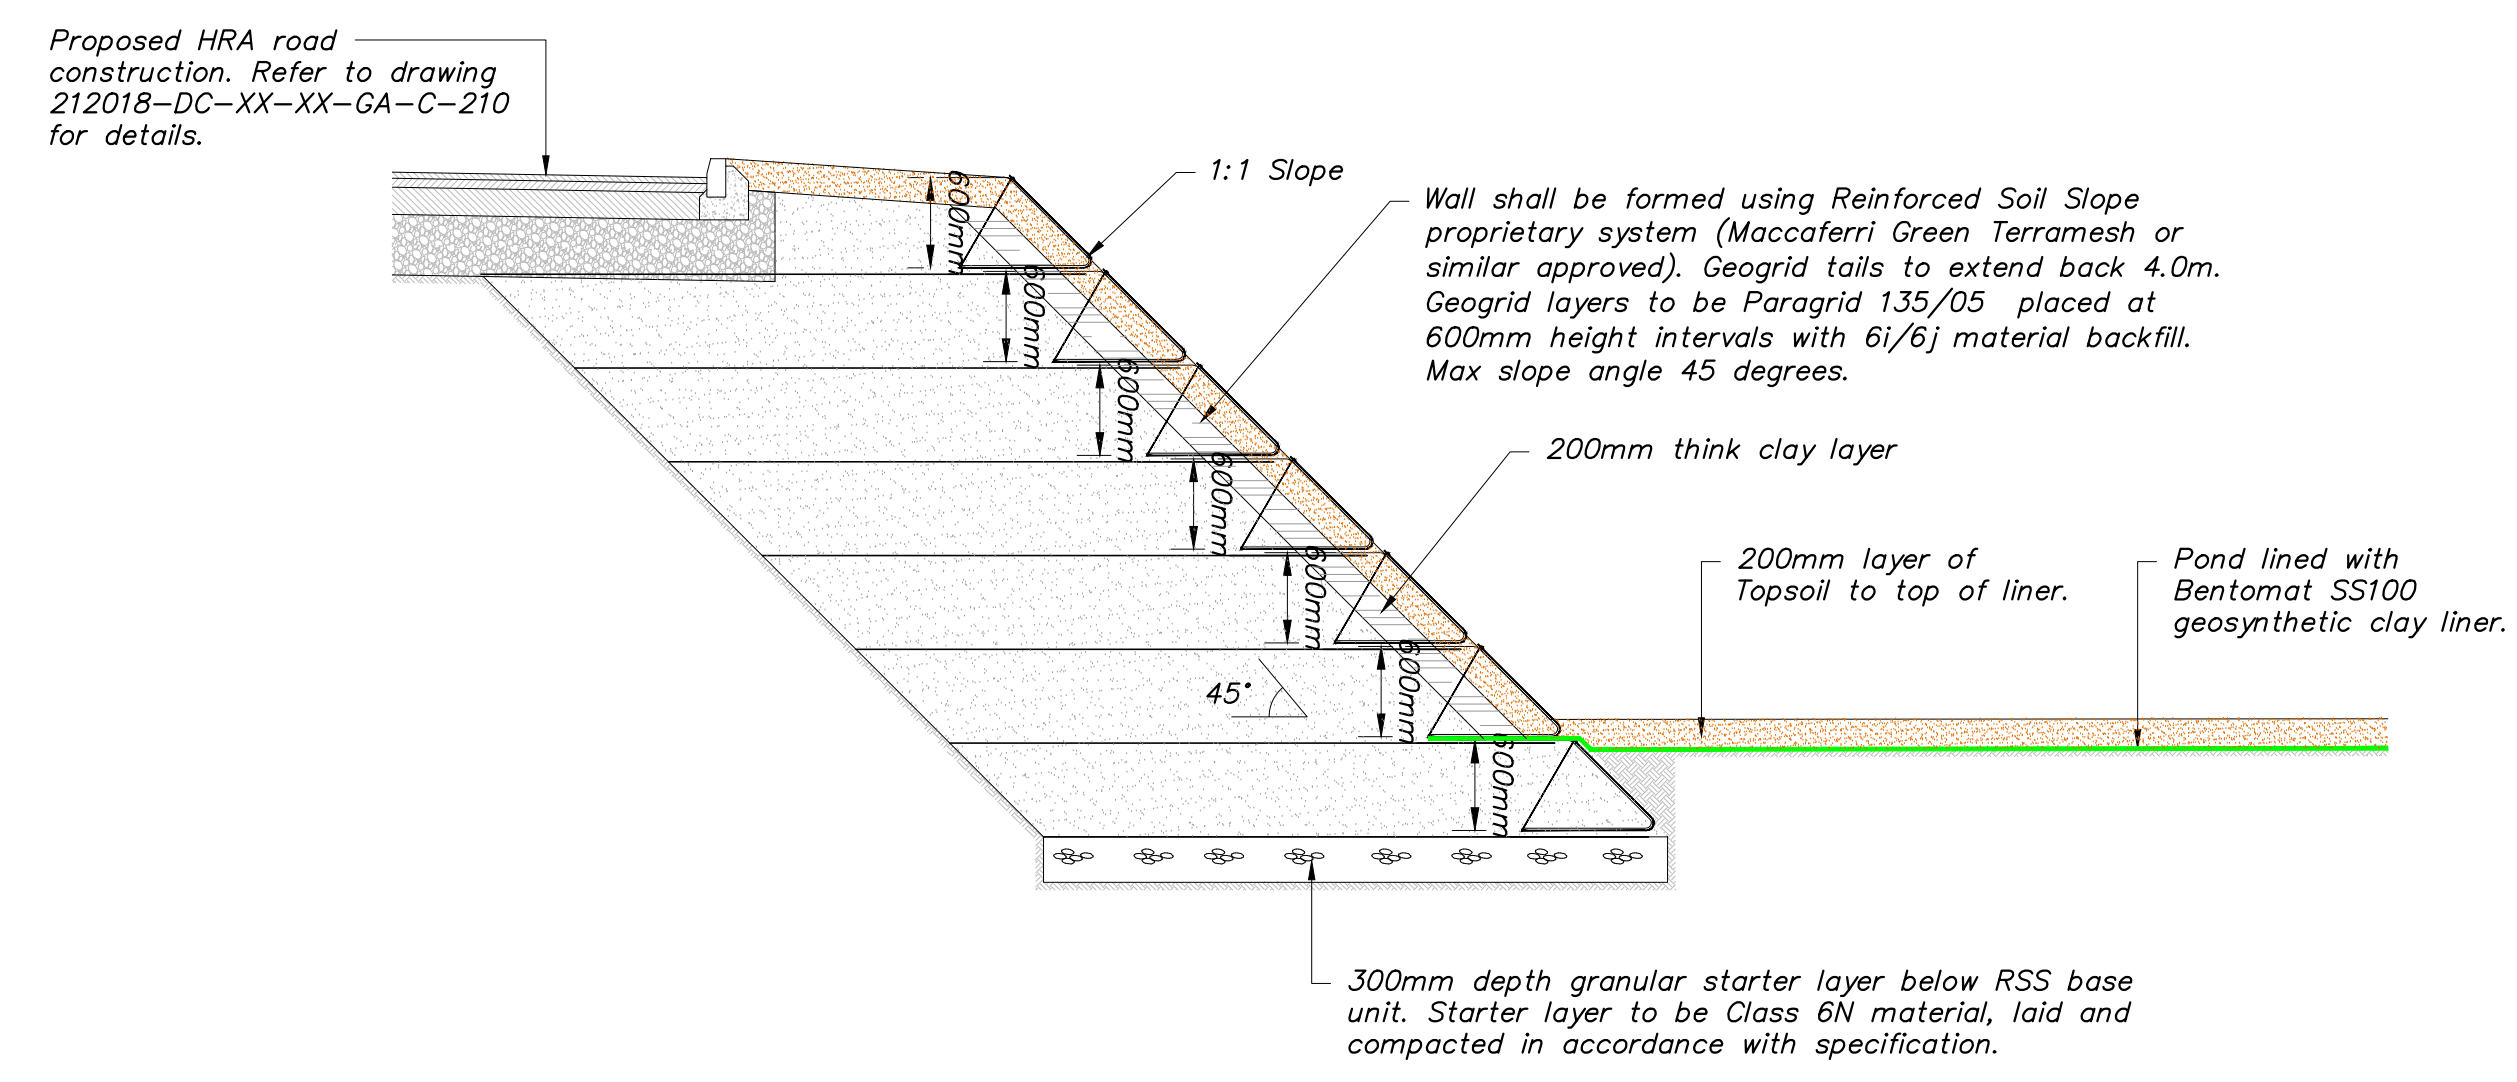

Earthwall Construction Detail
1:50

- Legend:**
- East Coast ECC-3 Erosion Control Blanket (ECB) or equal and approved
 - Bentotex 50 Geosynthetic Clay Liner (GCL)

Status	Date	By	Check	Drawing Status Details	Appr.

PRELIMINARY DRAWING

Project Title:
TEES VALLEY EFV

Drawing Title:
Proposed Pond Sections

Client/Architect:	HITACHI ZOSEN INOVA	Date:	June 2021
Drawn by:	DRM	Checked by:	AC
Approved by:	PGK	Sheet Size:	A0
Project Number:	212018	Orig:	DC
Zone:	XX	Level:	XX
Type:	GA	Disc:	C
Number:	312	Revision:	P03