


Notes

1. DO NOT SCALE FROM DRAWING

SCALE BAR

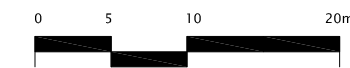

KEY

- E_{xx} EMITTER
- S_{xx} EMISSION SOURCE
- - - SITE BOUNDARY
- ELIGIBLE PROCESS
- DIRECTLY ASSOCIATED
- INELIGIBLE

© Crown copyright and database rights
2016 OS Licence 100035409

Rev	Date	Description	By
A	28.11.16	First Draft for review	LR

Amendments

Project
Spring Park

Title
P2 EU -ETS

Floor




Ark Commercial in Confidence

CONFIDENTIAL



Designed by	LR	Checked by	PS	Project No
Drawn by	LR	Date	28/11/2016	

Scale 1:250

Number	SP/SQ17/EU/ETS/0001	Revision	A
--------	---------------------	----------	---

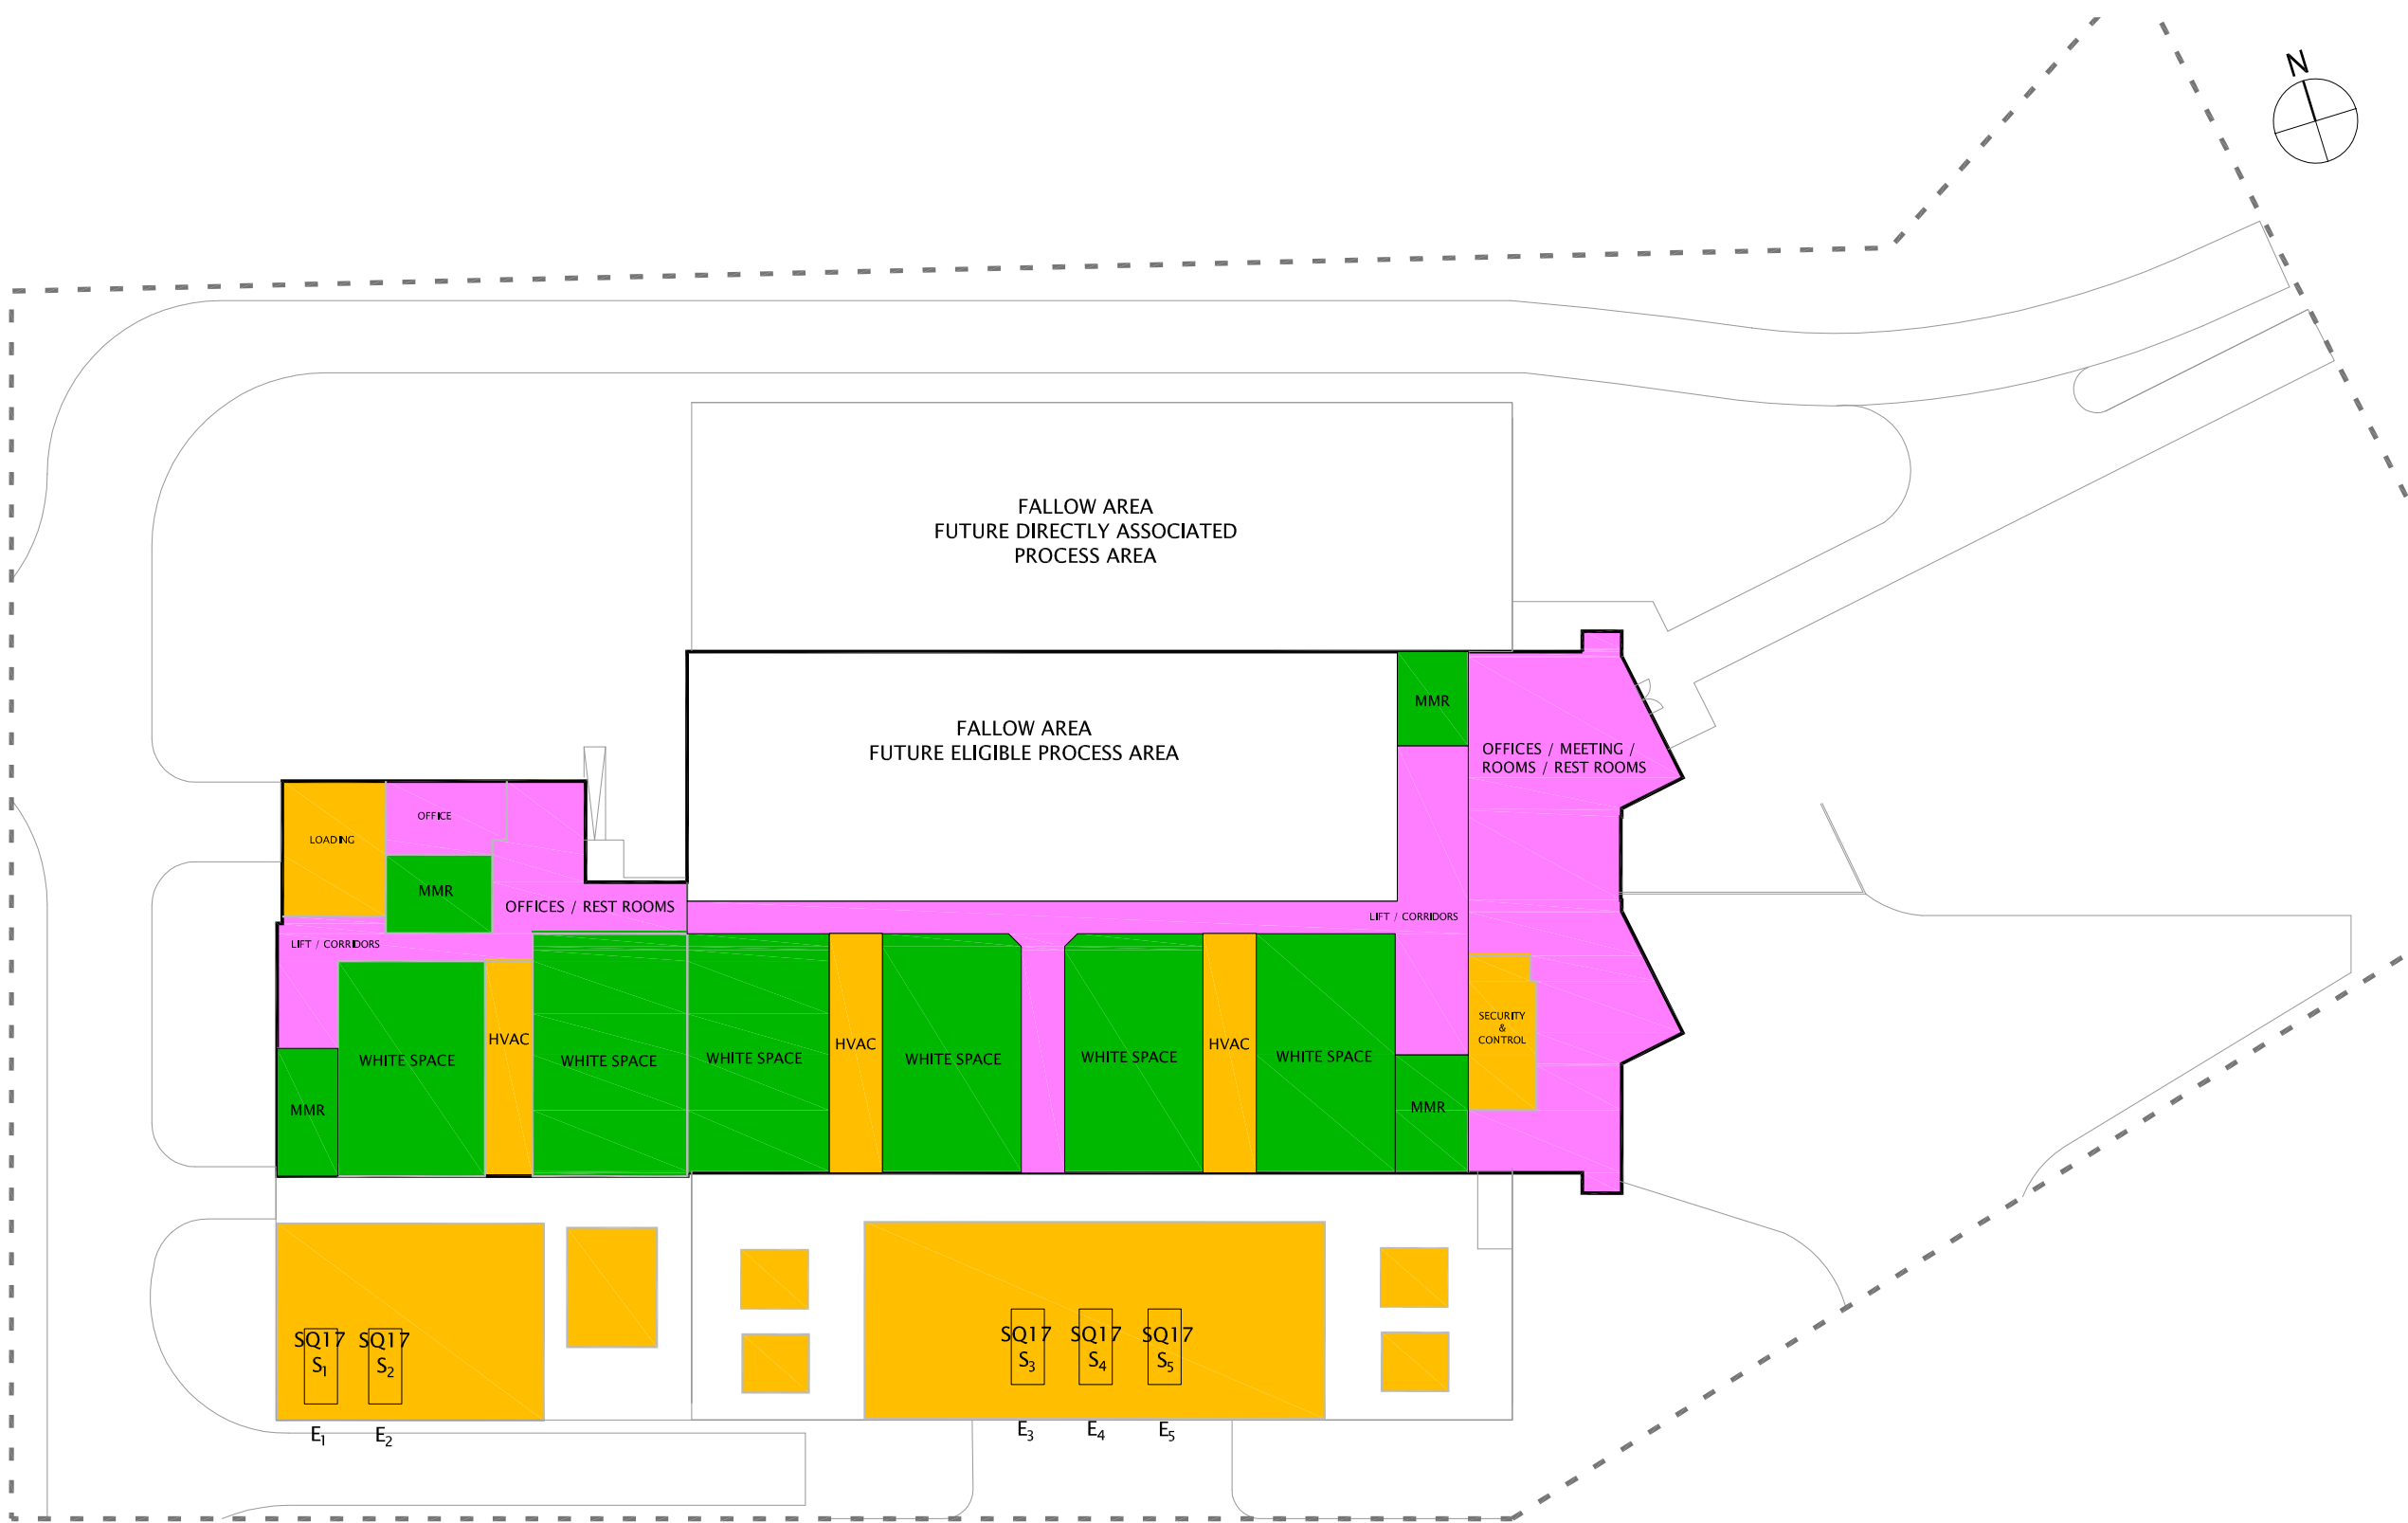

NOTES:
FOR INFORMATION

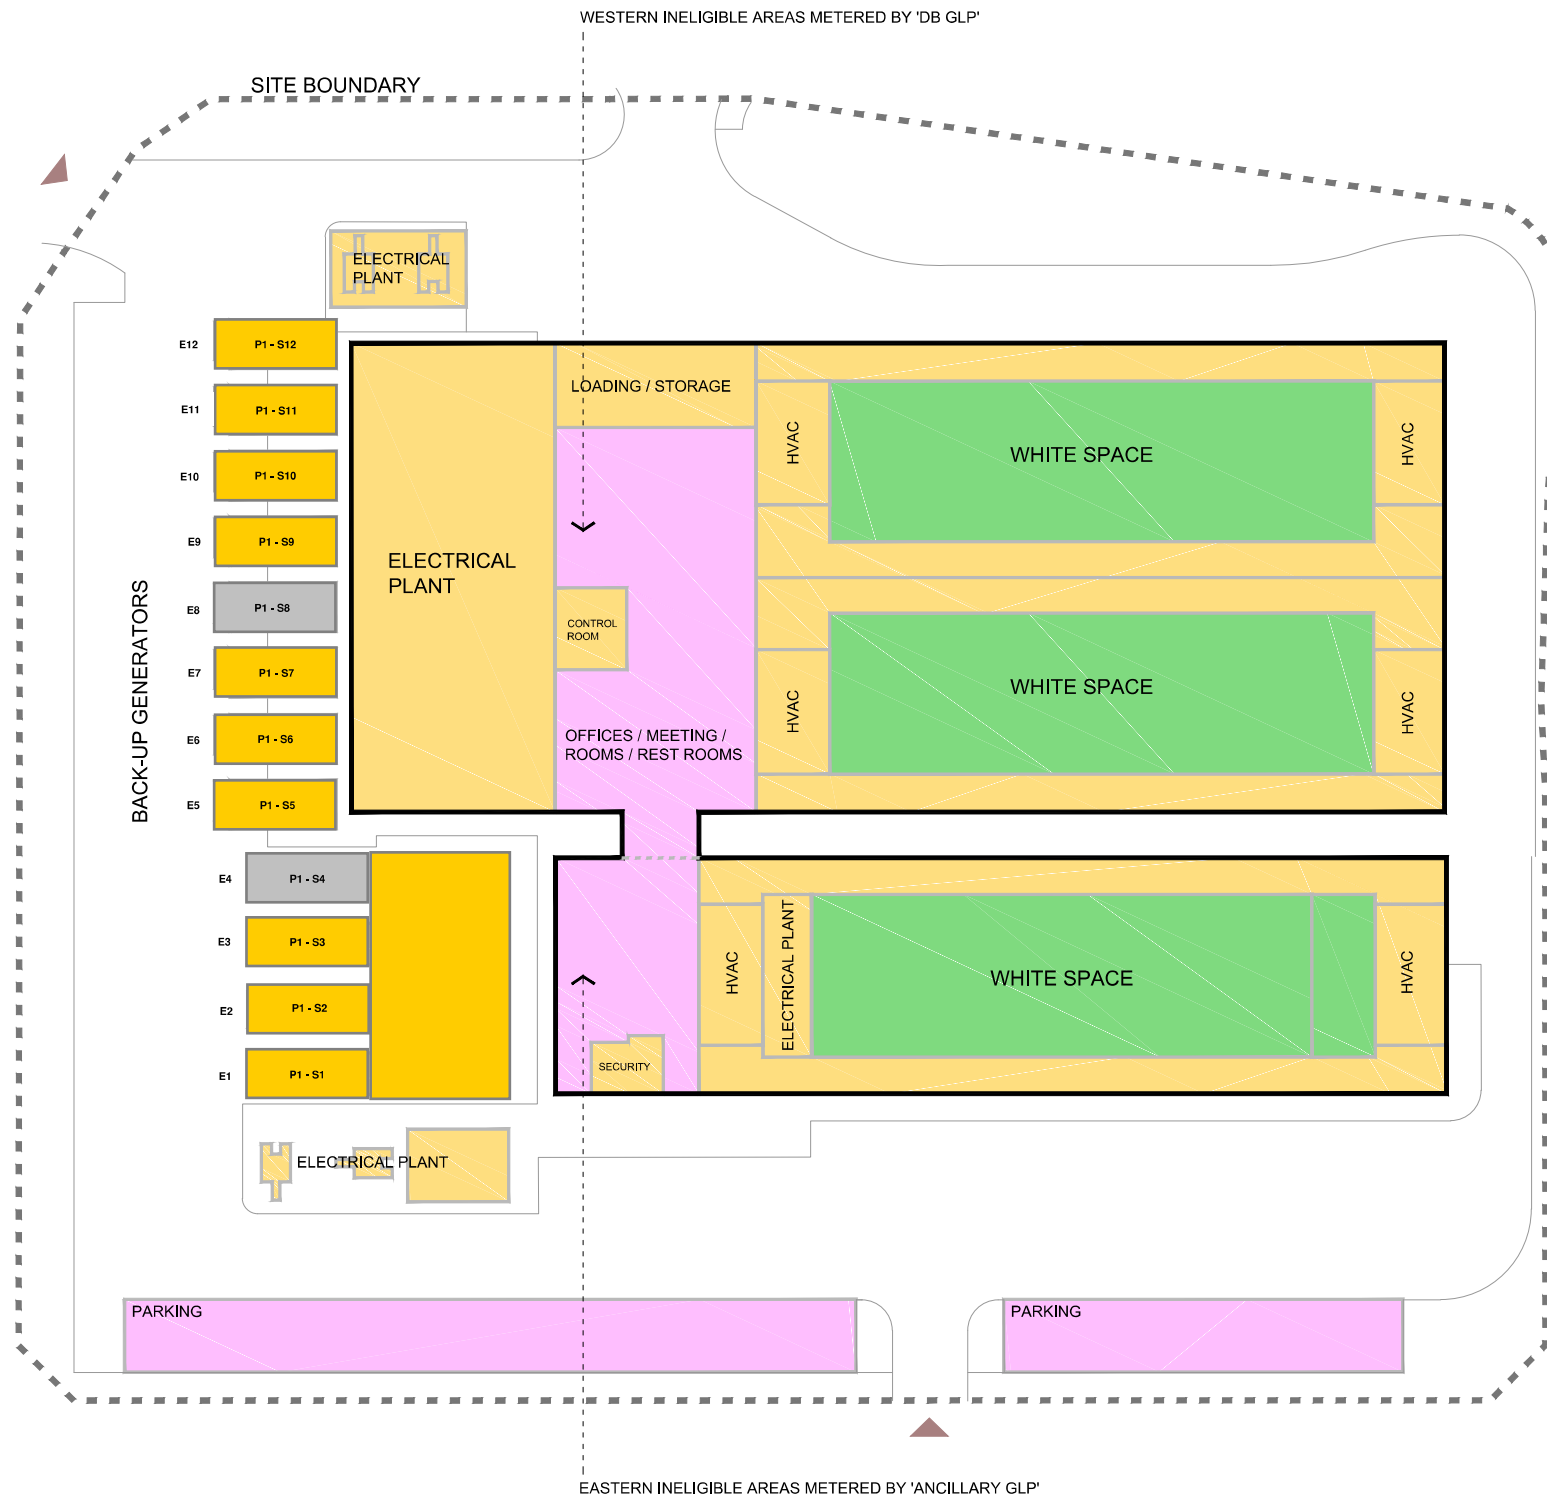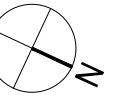

KEY

- SITE BOUNDARY
- ELIGIBLE PROCESS
- DIRECTLY ASSOCIATED
- INELIGIBLE
- FUTURE
- EMITTER
- EMISSION SOURCE

0 5 10 20m
SCALE 1:500

Rev: Notes: Date: Dwn: Iss:



hale
ARCHITECTURE | DESIGN MANAGEMENT
198a, Providence Square, Jacob Street, London, SE1 2DZ

Project:
P1, SPRING PARK

IED EMISSIONS DIAGRAM


Project No: -	Scale @ A1/A3: 1:500@A3	Revision: 01
Drawing No: SK01		

This drawing should not be scaled. Dimensions to be verified on site.
 Any discrepancies should be referred to the Engineer prior to work being put in hand.
 This drawing is the property of Waterman Infrastructure & Environment Limited, and the drawing is issued on the condition that it is not copied, reproduced, related or disclosed to any unauthorised person, either wholly or in part without the consent in writing of Waterman Infrastructure & Environment Limited.
 Pickfords Wharf, Clink Street, London SE1 9DG 1 020 7928 7888 1 020 7902 0992

GENERAL NOTES

1. THIS DRAWING IS TO BE READ IN CONJUNCTION WITH ALL ENGINEER'S, ARCHITECT'S OR OTHER RELEVANT DRAWINGS AND SPECIFICATIONS.
2. ALL DIMENSIONS AND LEVELS ARE TO BE CHECKED ON SITE BY THE CONTRACTOR PRIOR TO PREPARING ANY WORKING DRAWINGS OR COMMENCING ON SITE.
3. THE CONTRACTOR MUST ENSURE AND WILL BE HELD RESPONSIBLE FOR THE OVERALL STABILITY OF THE BUILDING/STRUCTURE/EXCAVATION AT ALL STAGES OF THE WORK.
4. ALL WORK BY THE CONTRACTOR MUST BE CARRIED OUT IN SUCH A WAY THAT ALL REQUIREMENTS UNDER THE HEALTH AND SAFETY AT WORK ACT ARE SATISFIED.
5. ALL WORK IS TO BE CARRIED OUT IN COMPLIANCE WITH THE REQUIREMENTS OF THE RELEVANT STATUTORY AUTHORITIES AND REGULATIONS.

Exx EMITTER
 Sxx EMISSION SOURCE
 HVG STANDBY HV GENERATOR

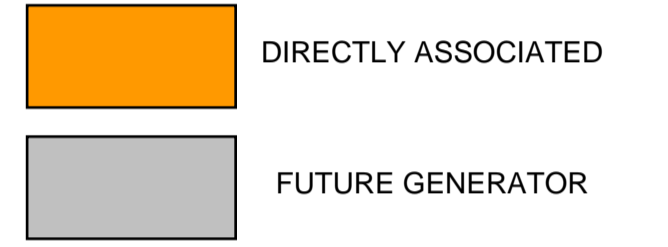


Rev	Date	Description	By
A01	10.12.18	ISSUED FOR INFORMATION	SH

Amendments
 Project **ARK DATA CENTRE - SPRING PARK HV STANDBY GENERATOR SCHEME**
 Title **FACILITY SITE PLAN**
 EMISSION SOURCES AND EMISSION POINTS



Drawing Status **FOR INFORMATION**

Designed by	SH	Checked by	AG	Project No	WIE11565
Drawn by	SH	Date	DECEMBER 2018	Computer File No	WIE-11565-SA-90-1000-A01.dwg
Scopes @ A1	work to figured dimensions only		1:200 @A1	Number	1000
DECOMMISSIONING / DEMOLITION	1.	2.	3.	Revision	A01

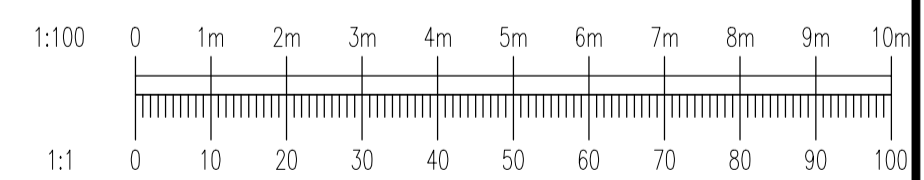

SAFETY, HEALTH AND ENVIRONMENTAL INFORMATION UNUSUAL SIGNIFICANT HAZARDS

It is assumed that all works will be carried out by a competent contractor working, where appropriate, to an approved method statement. In addition to the hazards/risks normally associated with the types of work detailed on this drawing, note the following:

- CONSTRUCTION
 - 1.
 - 2.
 - 3.
- MAINTENANCE / CLEANING
 - 1.
 - 2.
 - 3.
- DECOMMISSIONING / DEMOLITION
 - 1.
 - 2.
 - 3.