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- NOTES**
1. ALL DIMENSIONS ARE IN MILLIMETERS, LEVELS AND COORDINATES ARE IN METERS, UNLESS NOTED OTHERWISE.
 2. ALL ELEVATIONS REFER TO EL(±)0.000M EQUIVALENT TO (+)106.500M ABOVE ORDINANCE DATUM (AOD).
 3. THE DRAIN CONCEPT SHOWN HERE IS PRELIMINARY AND SHALL BE VERIFIED DURING DETAILED DESIGN STAGE.
 4. PRESSURIZED PIPE LINE ENVISAGED ABOVE GROUND LEVEL, SAME WILL BE VERIFIED DURING DETAILED ENGINEERING STAGE.
 5. THE EXCAVATION OF THE BUNKER IS AS PER MECH GA. THE SAME SHALL BE VERIFIED DURING DETAILED ENGINEERING STAGE.
 6. LOCATION MAY BE REQUIRED TO BE ADJUSTED BASED UPON DESIGN OF AIR COOLED CONDENSER FOUNDATION FOR BUNKER. THE SECANT PILING/ COMBI WALL/ SHEET PILING SHALL BE BEYOND THE EXCAVATION PROFILE SHOWN.
 7. * MARKED COORDINATES SHALL BE VERIFIED DURING DETAILED ENGINEERING STAGE.
 8. LOCATION MAY BE REQUIRED TO BE ADJUSTED BASED UPON PERMEABLE CAR PARKING AREA AND LAND DRAIN LAYOUT.

- LEGENDS**
- EXCAVATION
 - OILY WATER SEPARATOR
 - SILT TRAP
 - MANHOLE
 - CATCH PIT
 - ROAD STORM WATER NETWORK
 - LAND DRAINS FOR PARKING AND FUTURE ENVIRONMENTAL IMPROVEMENT AREA
 - ROOF STORM WATER NETWORK
 - PUMPING LINE
 - OUTLET DRAIN
 - EXPECTED LOCATION OF PENSTOCK VALVE (PENDING CONFIRMATION AT DETAILED DESIGN)


Rev	Description	By	CB	Date

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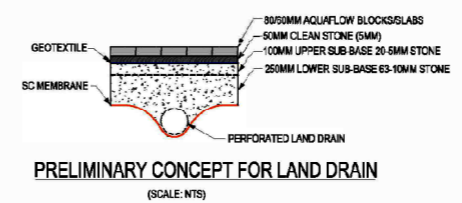
Client -
 Project Corby Energy from Waste Facility
 Title Drainage Plan

Status FINAL Drawn By JM PM/Checked By TH
 Project Number JER9793 Scale @ A3 NTS Date Created DEC 2022
 Figure Number - Rev -

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EXCAVATION AND STORM WATER DRAINAGE CONCEPT LAYOUT

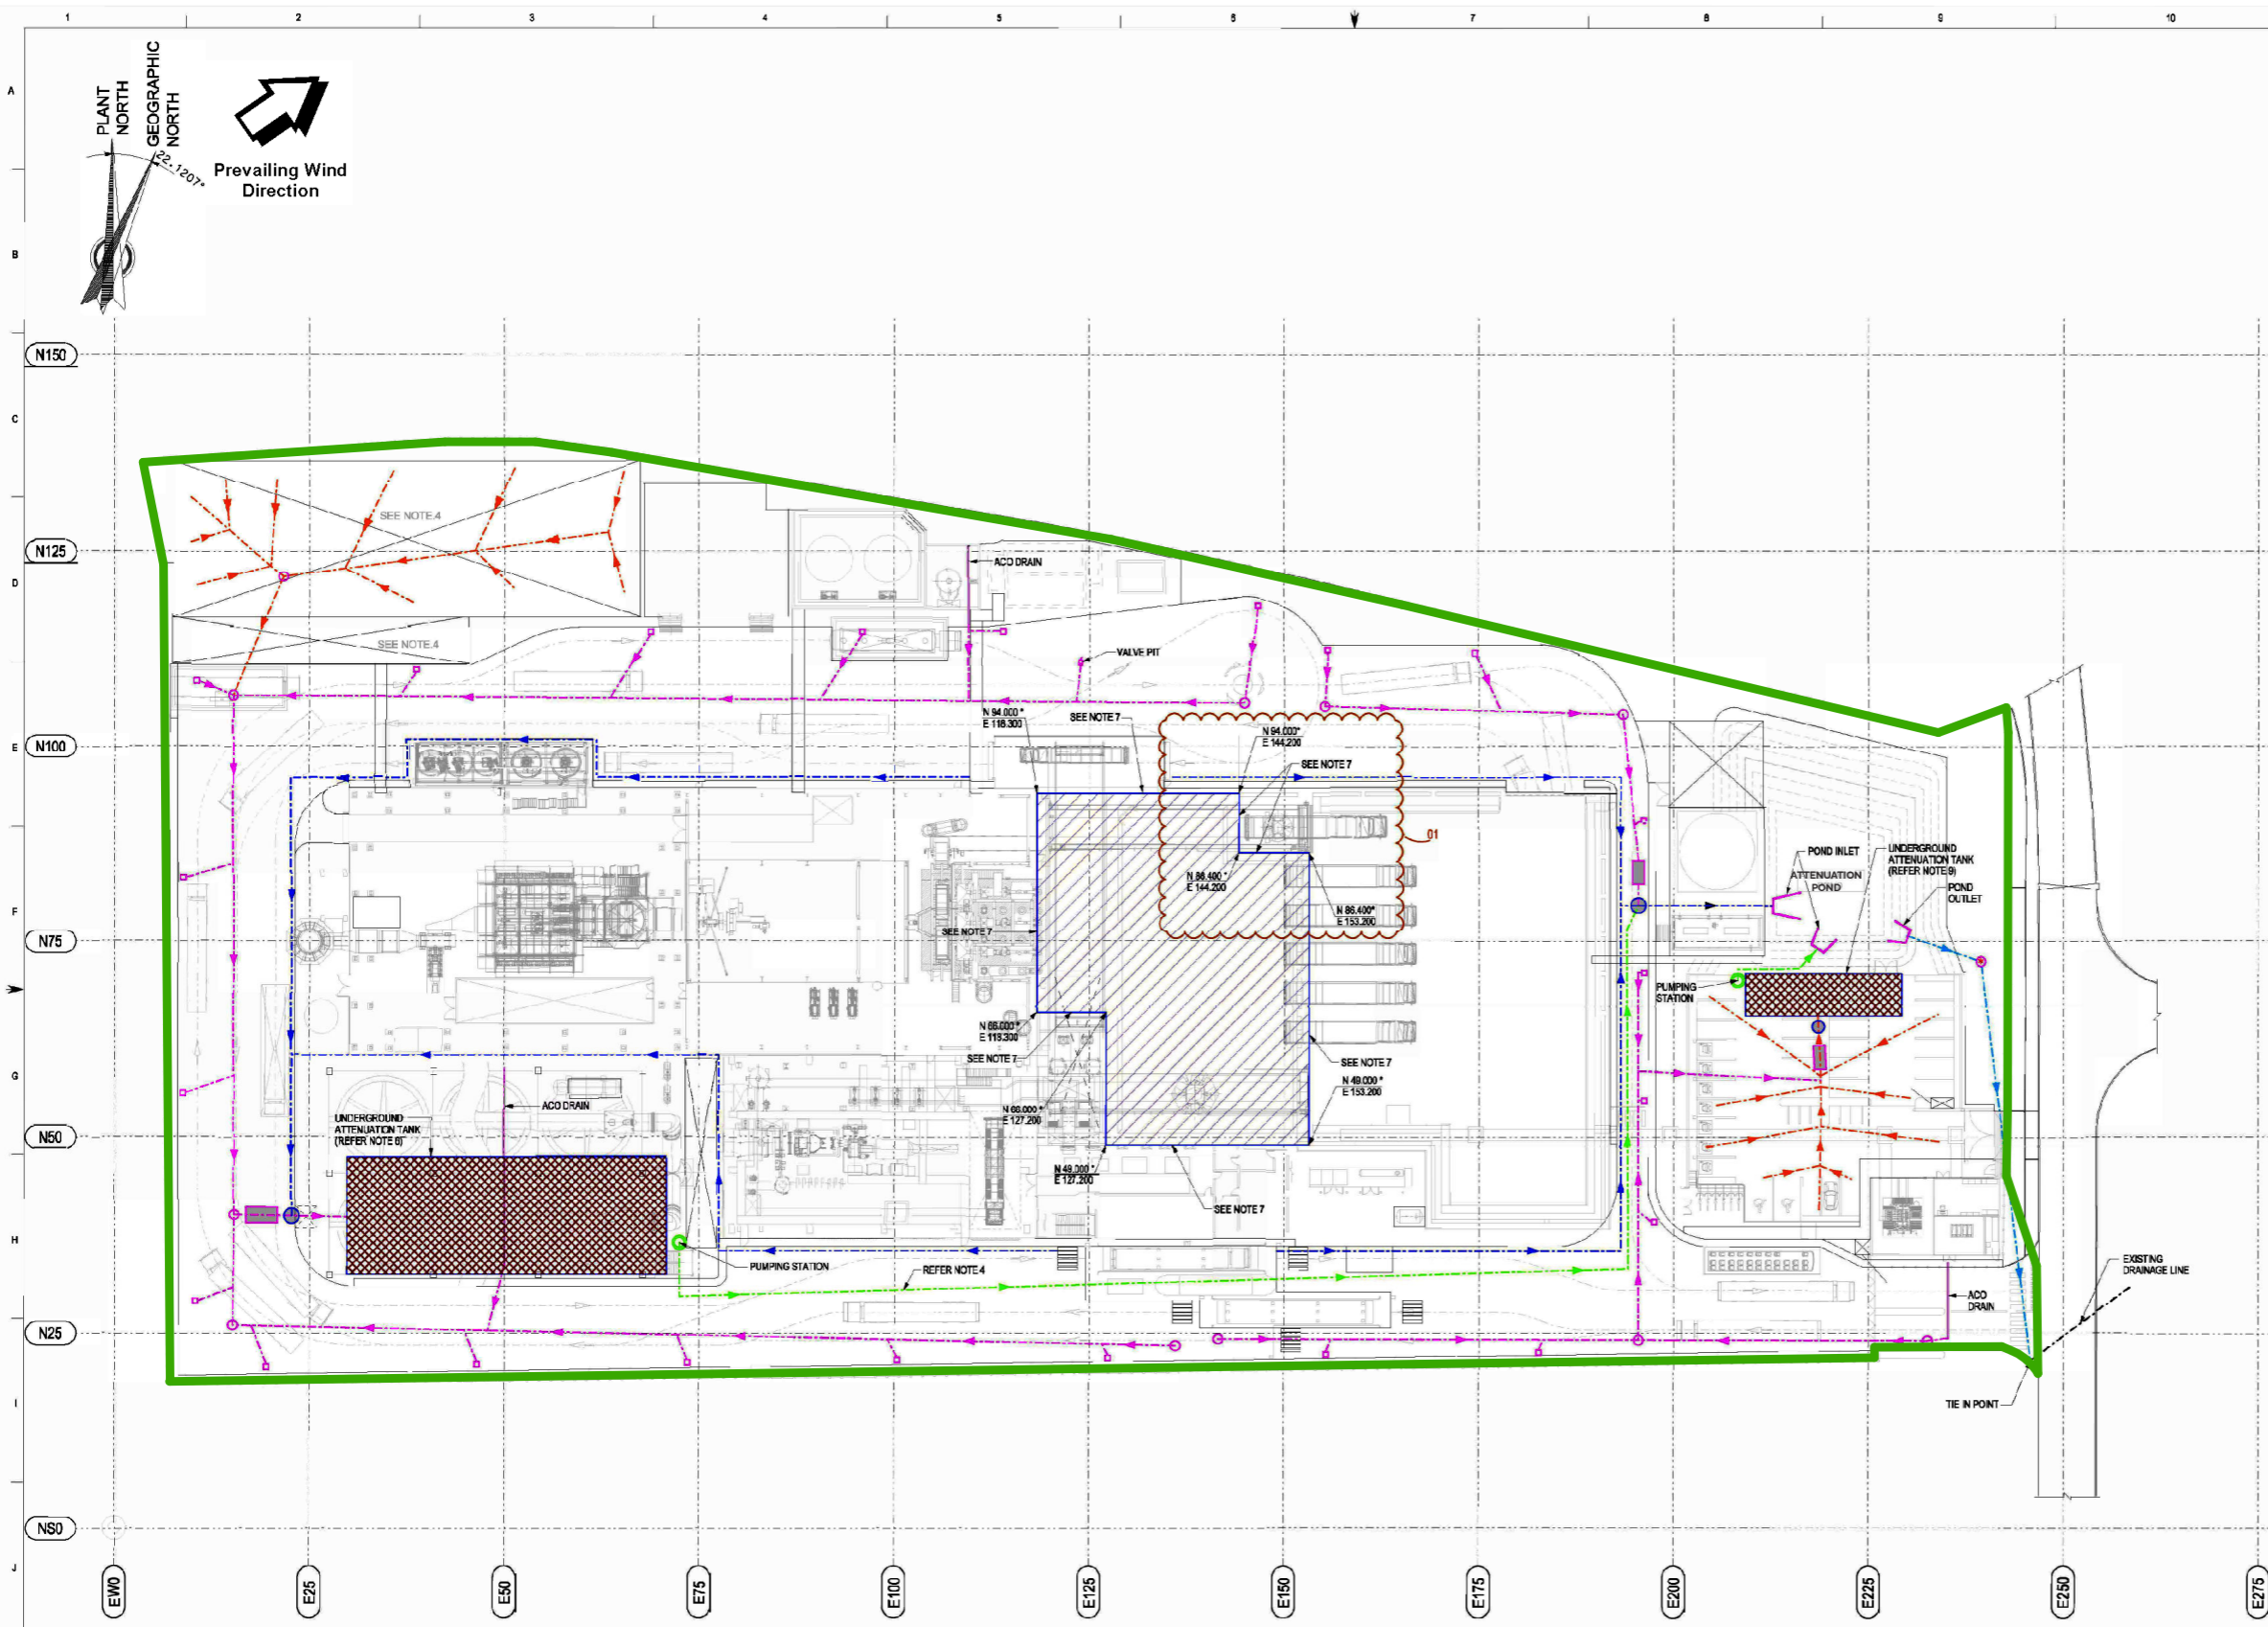

PRELIMINARY CONCEPT FOR LAND DRAIN (SCALE: NTS)