

ALL DIMENSIONS IN MM UNLESS OTHERWISE STATED

- SUMP DIMENSIONS**
- 0.9m x 1.2m x 2.1m deep
 - MH - 0.5m deep
 - 1.5mØ x 2.4m deep
 - 1.5mØ x 2.4m deep
 - FLUME - 1.0m deep
 - MH - 0.5m deep
 - MH - 1.2m deep
 - MH - 0.7m deep
 - 0.7m x 0.4m x 0.4m deep
 - 0.4m x 0.4m x 0.5m deep
 - 0.4m x 0.4m x 0.5m deep
 - 1.8m x 1.5m x 1.8m deep
 - 1.0m x 0.5m x 0.75m deep
 - Waste water collector

NOTES:



SEWAGE:
THE LOCATION OF SEWER LINES IS INDICATIVE ONLY, AND SHOW ONLY SEWER MAINS OWNED AND OPERATED BY UNITED UTILITIES. PRIVATE DRAINS OR OTHER CULVERTS MAY NOT BE SHOWN.

USERS MUST BE AWARE THAT THERE ARE TWO SEWER SYSTEMS UNDER THE SITE: ONE IS THE PUBLIC SEWER SYSTEM DISCHARGING TO UU TREATMENT PLANTS. THE OTHER IS A TIDAL OUTFLOW SYSTEM INTENDED TO HANDLE UU EMERGENCY OVERFLOWS ONLY. THE SITES TRADE EFFLUENT DISCHARGE CONSENT REQUIRES THAT UU ARE NOTIFIED PRIOR TO ANY FRESH CONNECTION INTO THE PUBLIC SEWER. CONNECTIONS INTO THE OUTFALL SYSTEM ARE NOT PERMITTED UNDER ANY CIRCUMSTANCE.

INFORMATION TAKEN FROM UNITED UTILITIES DRAWINGS S3296SW (SEWER) / 1749-2009 AND S3296E (SEWER) / 1749-2009. PLEASE NOTE THE ABOVE DRAWINGS DO NOT SHOW THE PUBLIC SEWER. ONLY THE TIDAL SYSTEM USERS SHALL REFER TO ALL OF THE FOLLOWING PRIOR TO UNDERTAKING ANY WORKS ON OR IN THE VICINITY OF WATER MAINS :-

HSE PUBLICATION	HSG47 - AVOIDANCE OF DANGER FROM UNDERGROUND SERVICES
CARGILL	SEWER PLANS SHOWING PRIVATE CONNECTIONS AND PUBLIC SEWER SYSTEM

USERS ARE TO BE AWARE THAT THIS DRAIN PLAN SHOWS ROUTES, BUT PHYSICAL LOCATIONS OF PIPES AND RUNS ARE APPROXIMATE ONLY. EXTREME CAUTION MUST BE EXERCISED IF UNDERTAKING EXCAVATION WORKS NEAR TO DRAINS THAT THE EXACT COURSE HAS BEEN CORRECTLY IDENTIFIED AND LOCATED.

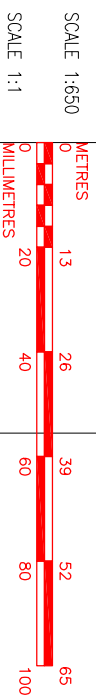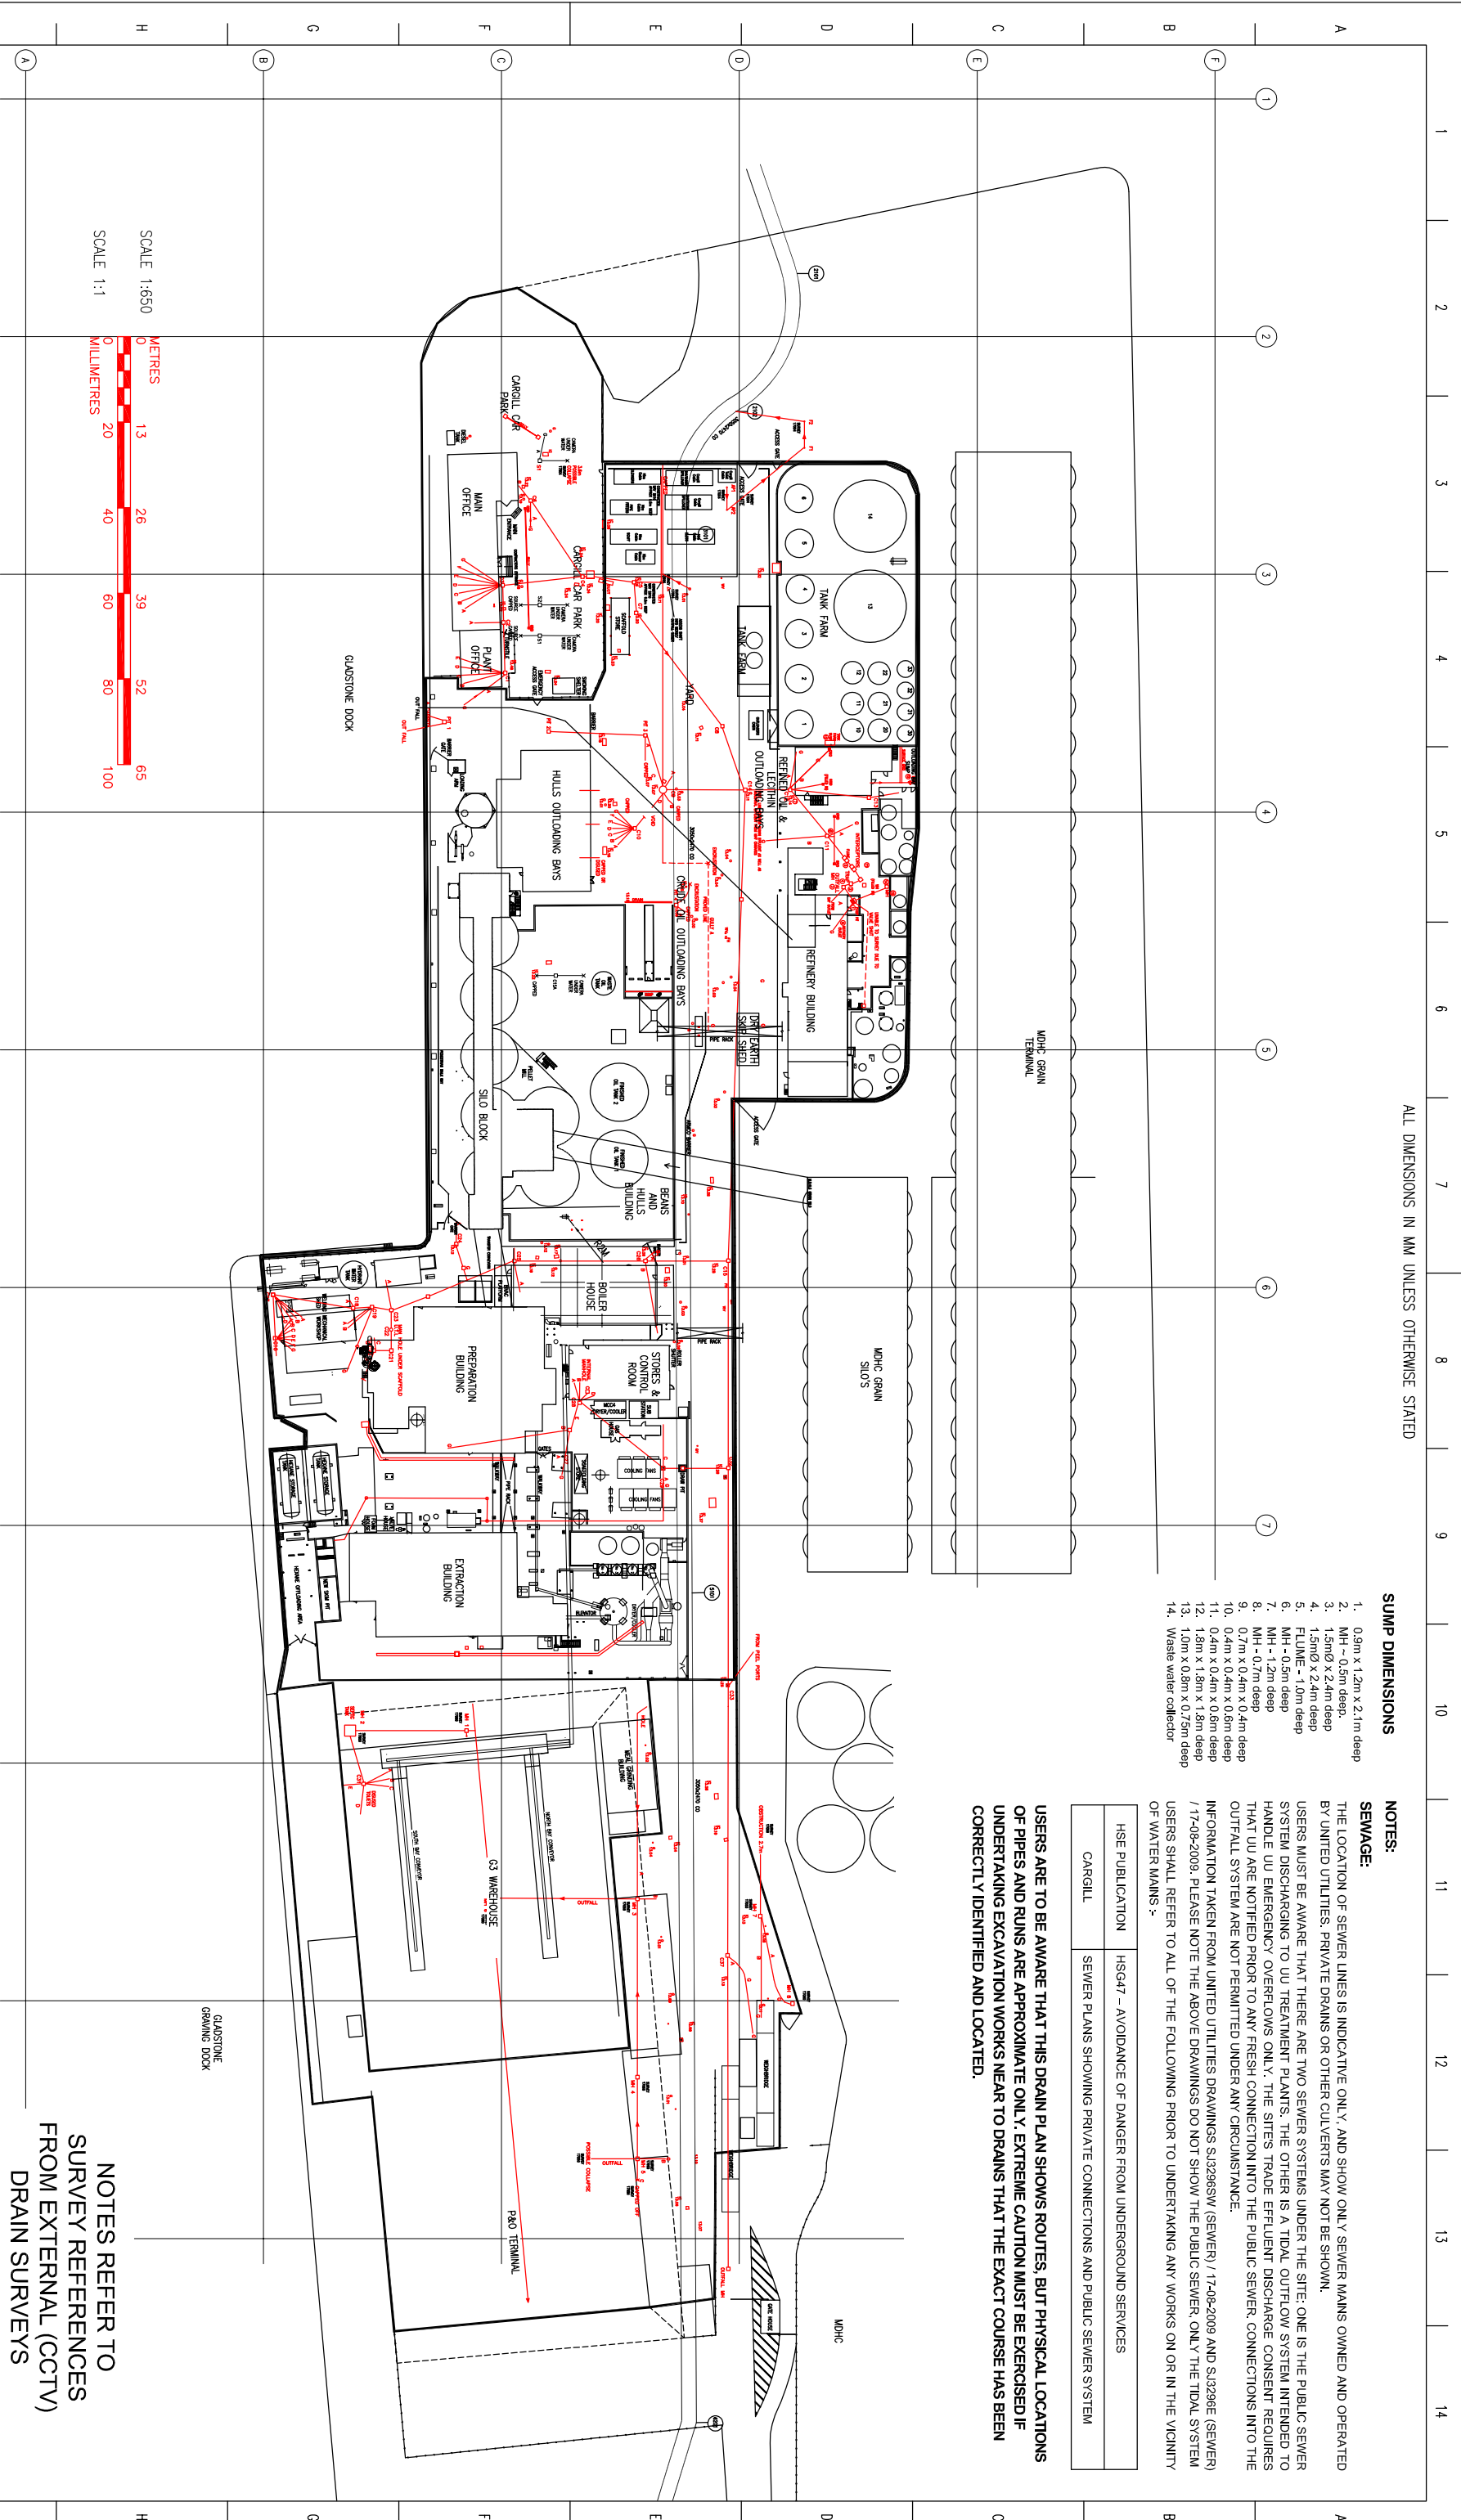

NOTES REFER TO SURVEY REFERENCES FROM EXTERNAL (CCTV) DRAIN SURVEYS

APPROVAL



Cargill PLC
Seaforth
Glaustone Dock
Boothle, Liverpool

TITLE
SITE PLAN
DRAINAGE POINTS

REV	DATE	DESCRIPTION	APPROVED	DATE	PREVIOUS REF. No.	DO NOT SCALE
C	05.09.2020	PM PROLEN - EMISSION POINTS GENERAL UPDATE				
B	28.03.2011	RE-ISSUED FOR GENERAL DRAWING UPDATES				
DRAWING No. C-00-9007-5						
DATE 13.01.2010						
ORIGINAL SCALE 1:900						
SHEET 5 of 30						
REV B						

MINIMUM TEXT SIZE 2.5mm TO SUIT MICROFILMING