
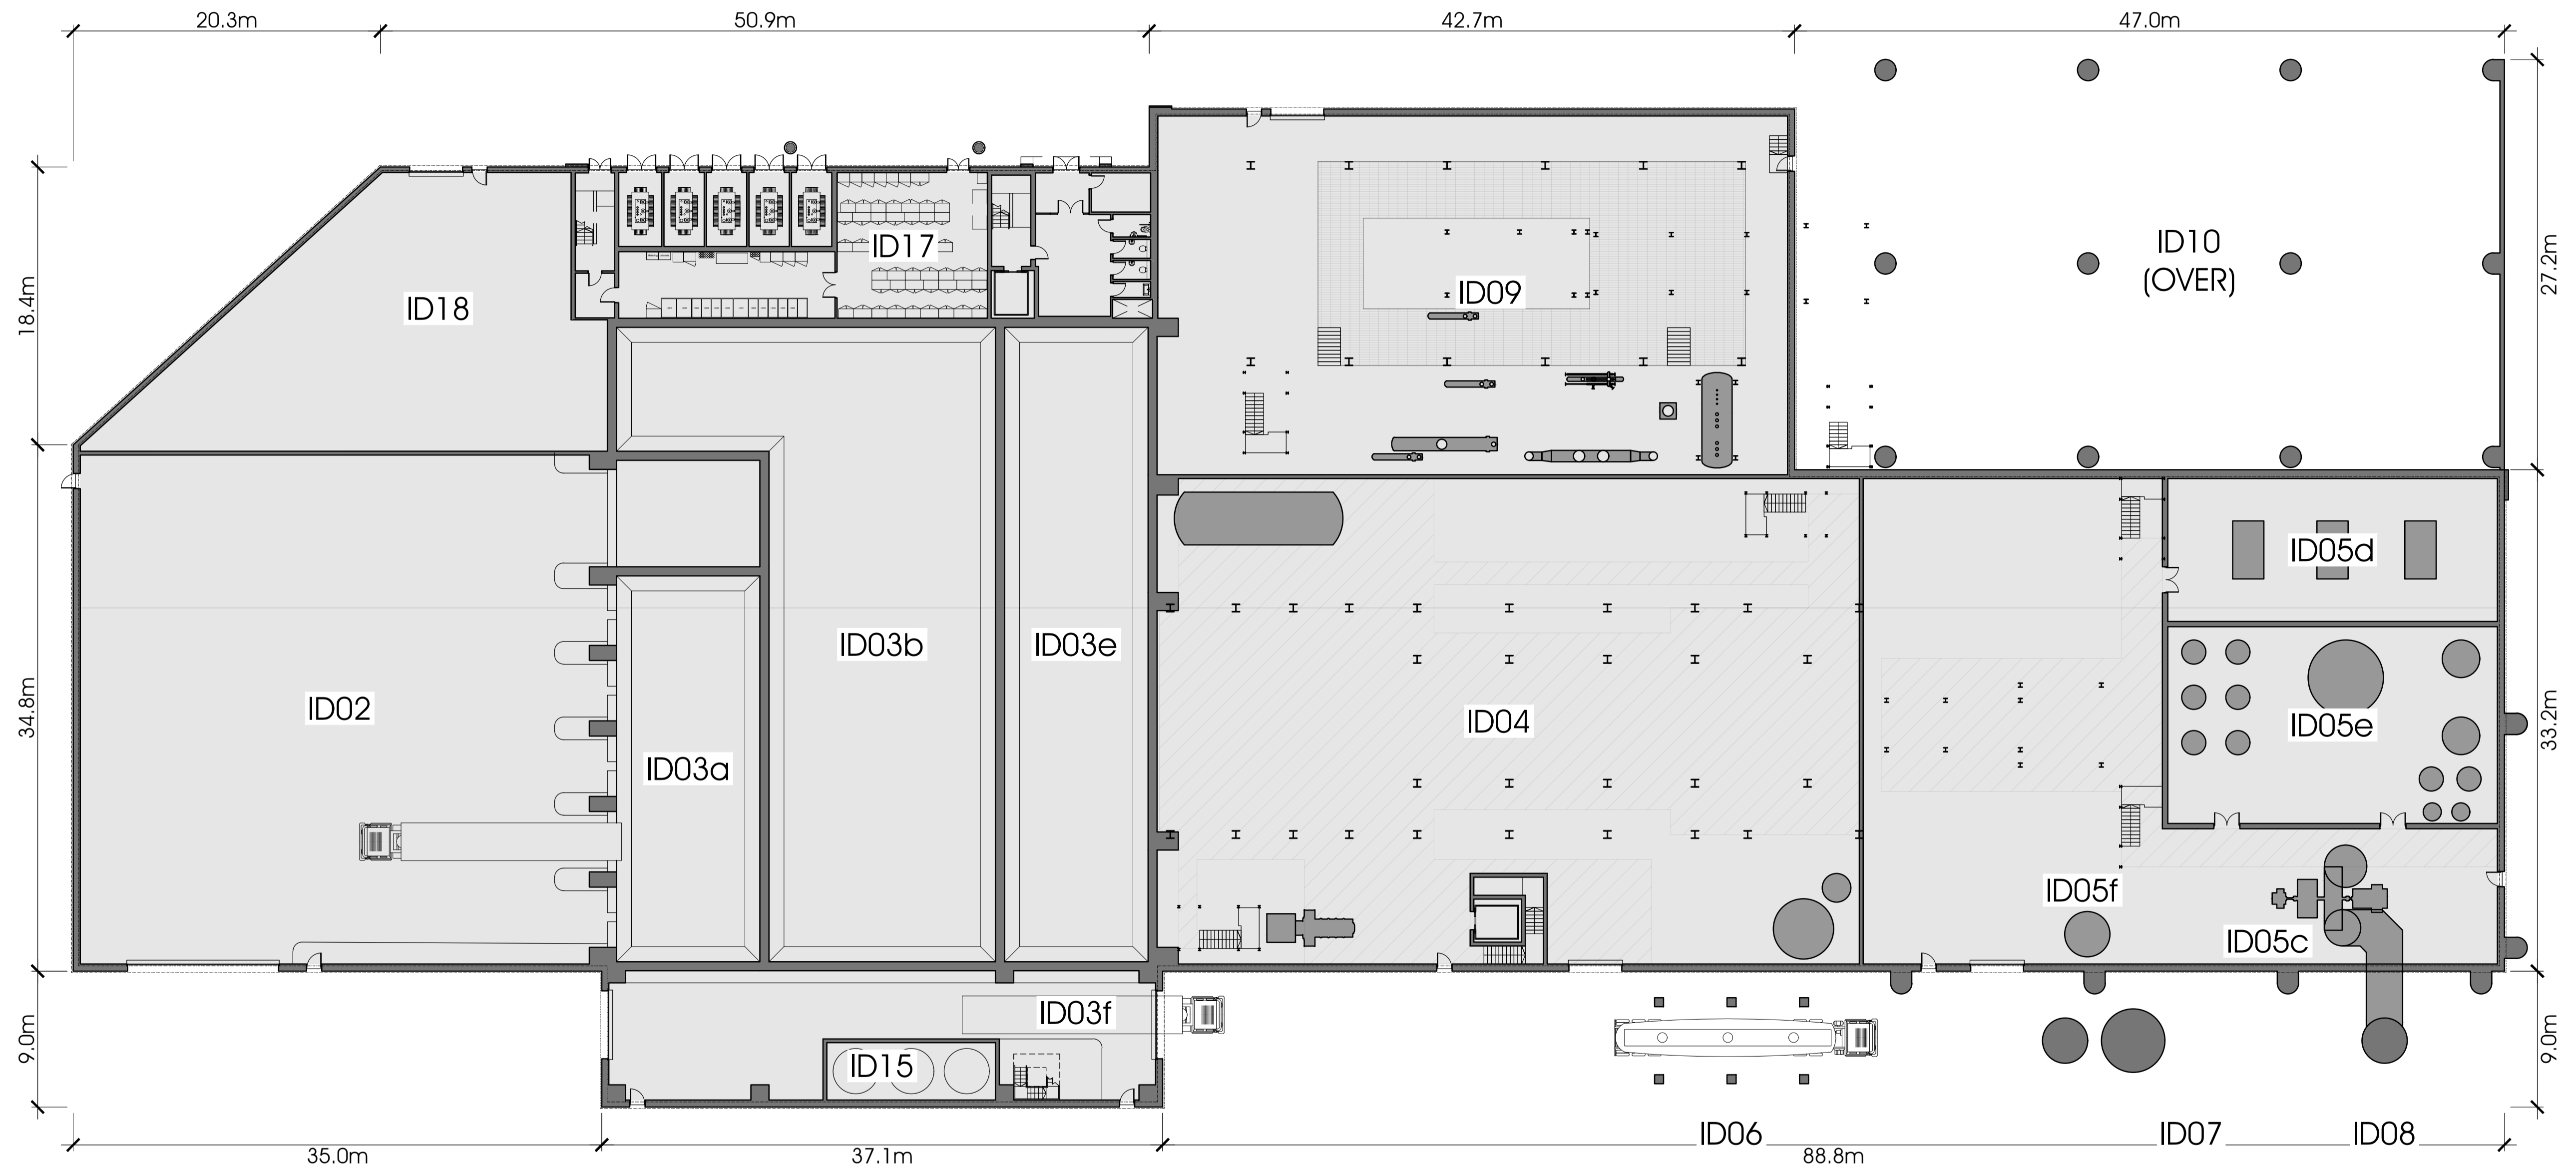


LEGEND

ID02: Tipping hall
 ID03: Waste bunker building
 (ID03a): Tipping bunker
 (ID03b): Main waste bunker
 (ID03d): Crane maintenance area
 (ID03e): IBA Bunker
 (ID03f): IBA loading enclosure
 (ID03g): Back loading hatch
 ID04: Boiler house


ID05: Air pollution control building
 (ID05a): APC plant and reactor
 (ID05b): Bag filter house
 (ID05c): Induced draft (ID) fan
 (ID05d): Compressed air station
 (ID05e): Water treatment plant
 (ID05f): Urea tank
 ID06: APCr silos
 ID07: Lime & activated carbon silos

ID08: Chimney & CEMS platform
 ID09: Turbine hall
 ID10: Air cooled condenser (ACC)
 ID15: Diesel tanks
 ID17: Switchgear building, administration building and control room
 ID18: Workshop & stores

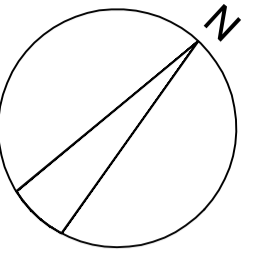


****ID04, ID05, ID09 & ID17 ARRANGEMENT OF INTERNAL EQUIPMENT INDICATIVE ONLY****

PLAN @ FFL 44.650m AOD
 SCALE 1 : 250 @ A1

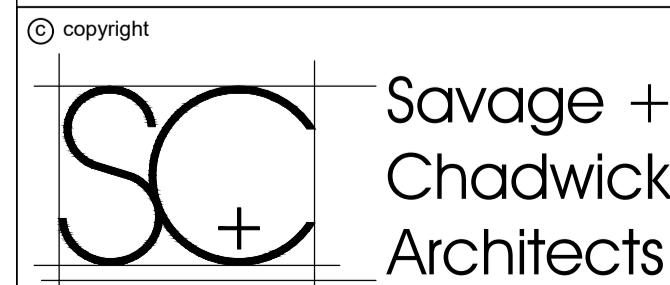

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rev	date	comment

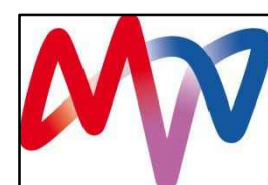client	MVV
project	ENERGY FROM WASTE, COMBINED HEAT & POWER FACILITY, CANFORD.

drawing
 PLAN @ FFL 44.650m AOD




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date	23/02/2023	drawn	NAB
project no.	SC1643/PL	drawing no.	10-03
		rev.	

LEGEND

ID02: Tipping hall
 ID03: Waste bunker building
 (ID03a): Tipping bunker
 (ID03b): Main waste bunker
 (ID03c): Crane maintenance area
 (ID03d): IBA Bunker
 (ID03e): IBA loading enclosure
 (ID03f): IBA loading hatch
 (ID03g): Back loading hatch
 ID04: Boiler house


ID05: Air pollution control building
 (ID05a): APC plant and reactor
 (ID05b): Bag filter house
 (ID05c): Induced draft (ID) fan
 (ID05d): Compressed air station
 (ID05e): Water treatment plant
 (ID05f): Urea tank
 ID06: APCr silos
 ID07: Lime & activated carbon silos

ID08: Chimney & CEMS platform
 ID09: Turbine hall
 ID10: Air cooled condenser (ACC)
 ID15: Diesel tanks
 ID17: Switchgear building, administration building and control room
 ID18: Workshop & stores

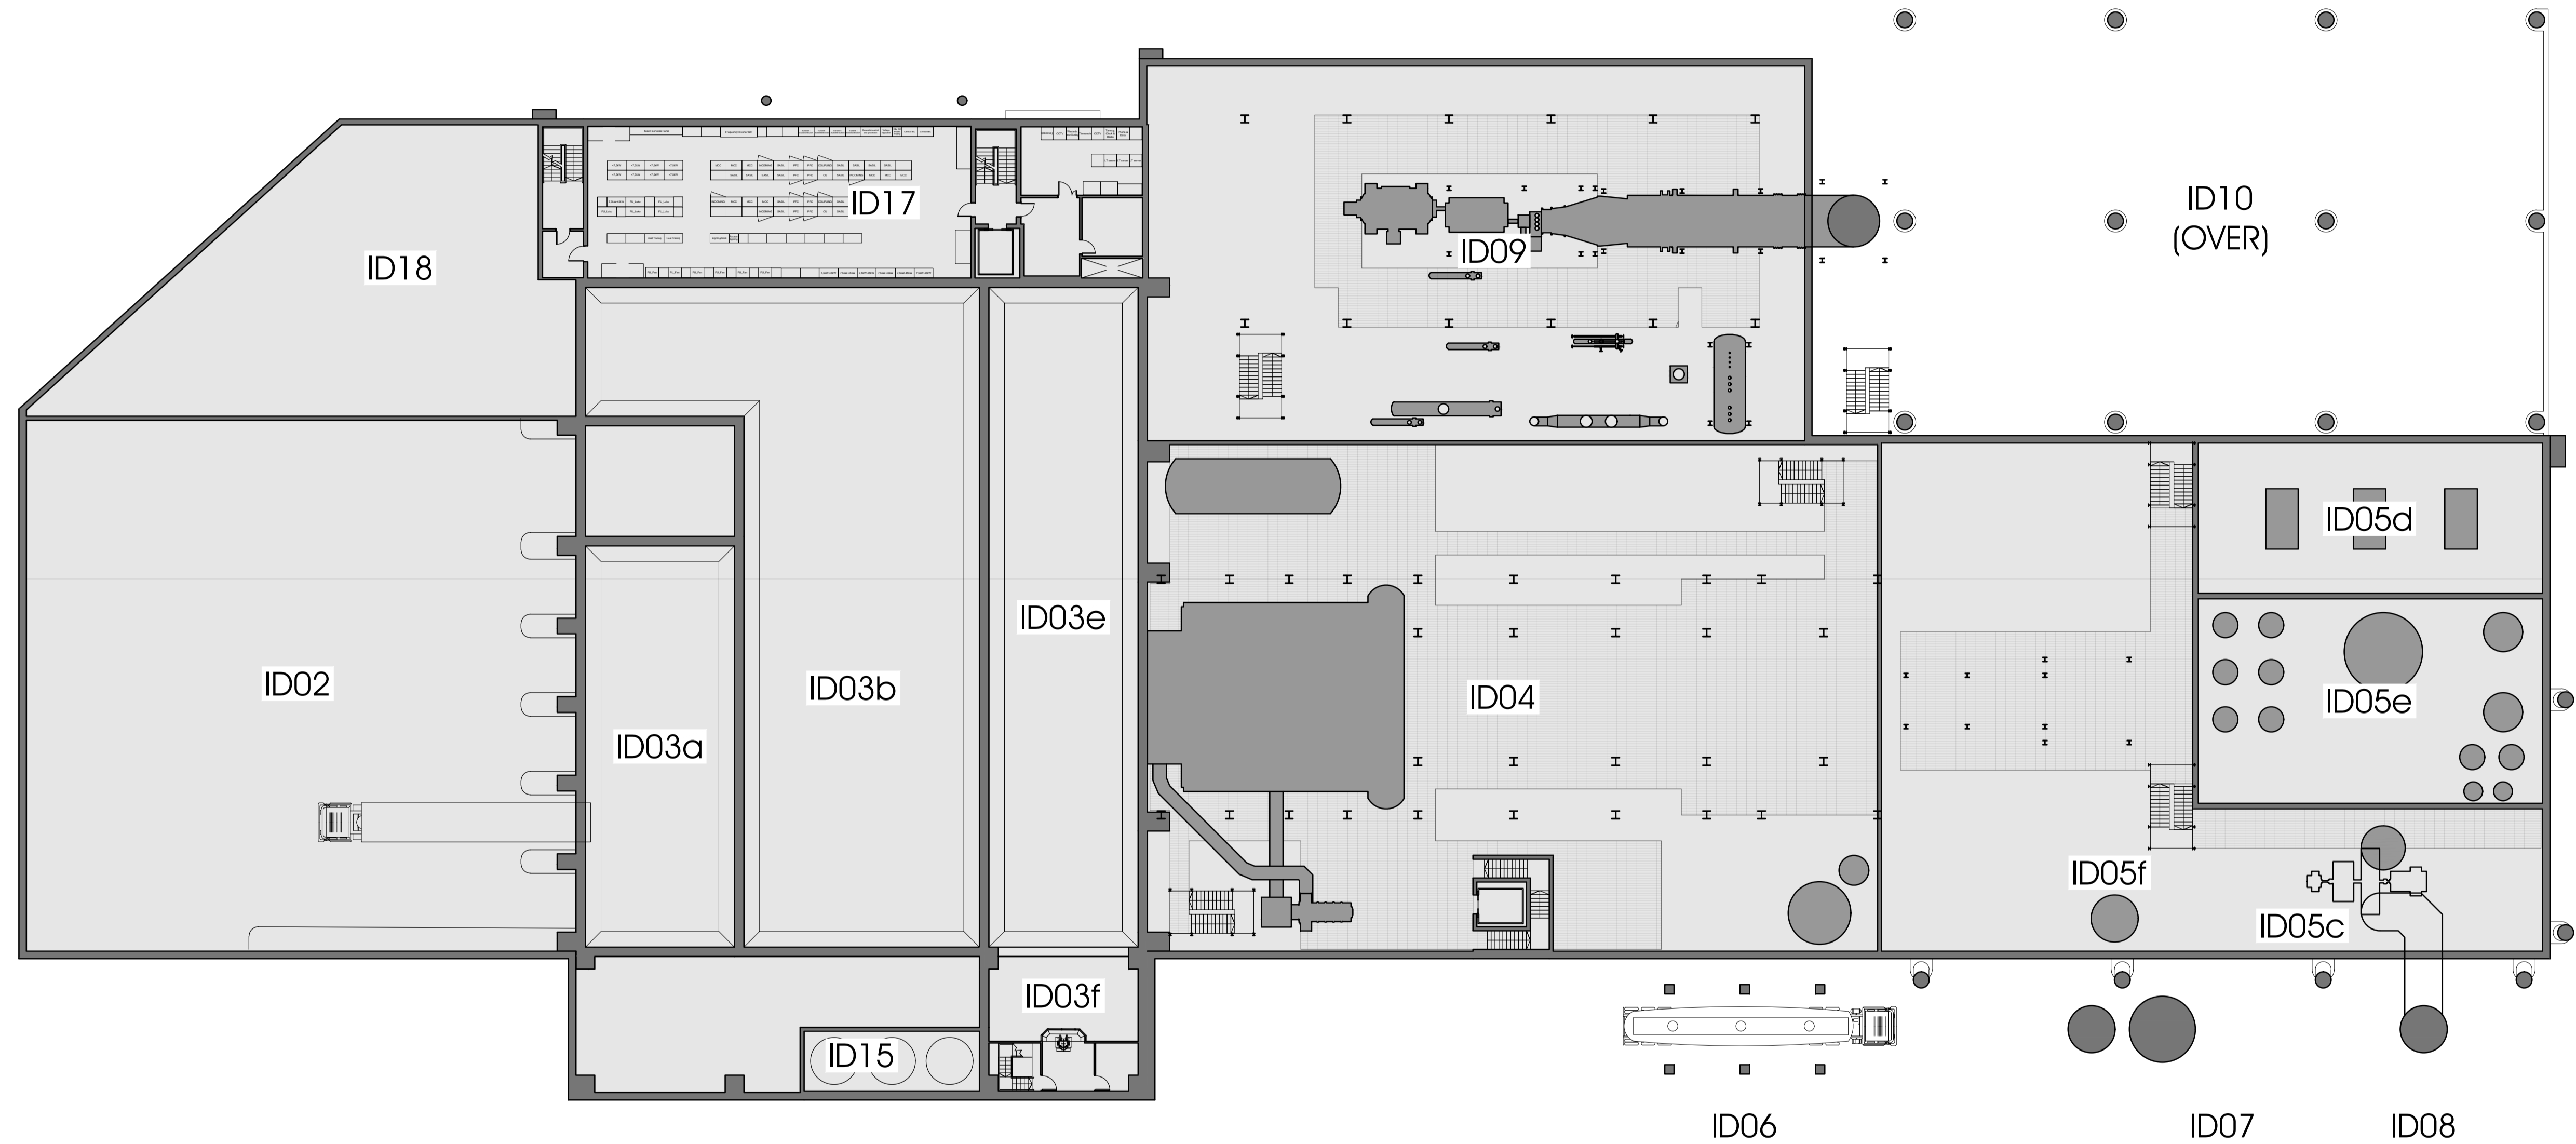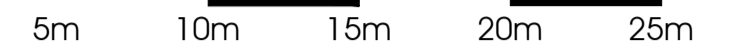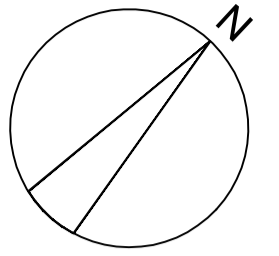


****ID04, ID05, ID09 & ID17 ARRANGEMENT OF INTERNAL EQUIPMENT INDICATIVE ONLY****

PLAN @ FFL 51.425m AOD
 SCALE 1 : 250 @ A1

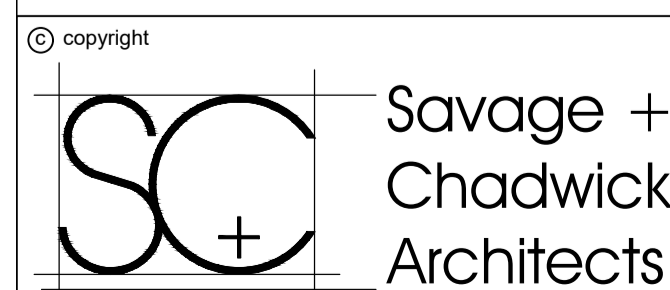

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rev	date	comment

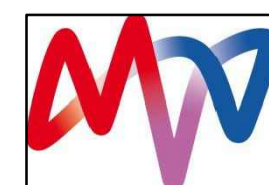client	MVV
project	ENERGY FROM WASTE, COMBINED HEAT & POWER FACILITY, CANFORD.

drawing PLAN @ FFL 51.425m AOD



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date	23/02/2023	drawn	NAB
project no.	SC1643/PL	drawing no.	10-04
		rev.	

LEGEND

ID02: Tipping hall
 ID03: Waste bunker building
 (ID03a): Tipping bunker
 (ID03b): Main waste bunker
 (ID03c): Waste chute platform
 (ID03d): Crane maintenance area
 (ID03g): Back loading hatch
 ID04: Boiler house


ID05: Air pollution control building
 (ID05a): APC plant and reactor
 (ID05b): Bag filter house
 (ID05c): Induced draft (ID) fan
 (ID05d): Compressed air station
 (ID05e): Water treatment plant
 (ID05f): Urea tank
 ID06: APCr silos

ID07: Lime & activated carbon silos
 ID08: Chimney & CEMS platform
 ID09: Turbine hall
 ID10: Air cooled condenser (ACC)
 ID17: Switchgear building, administration building and control room

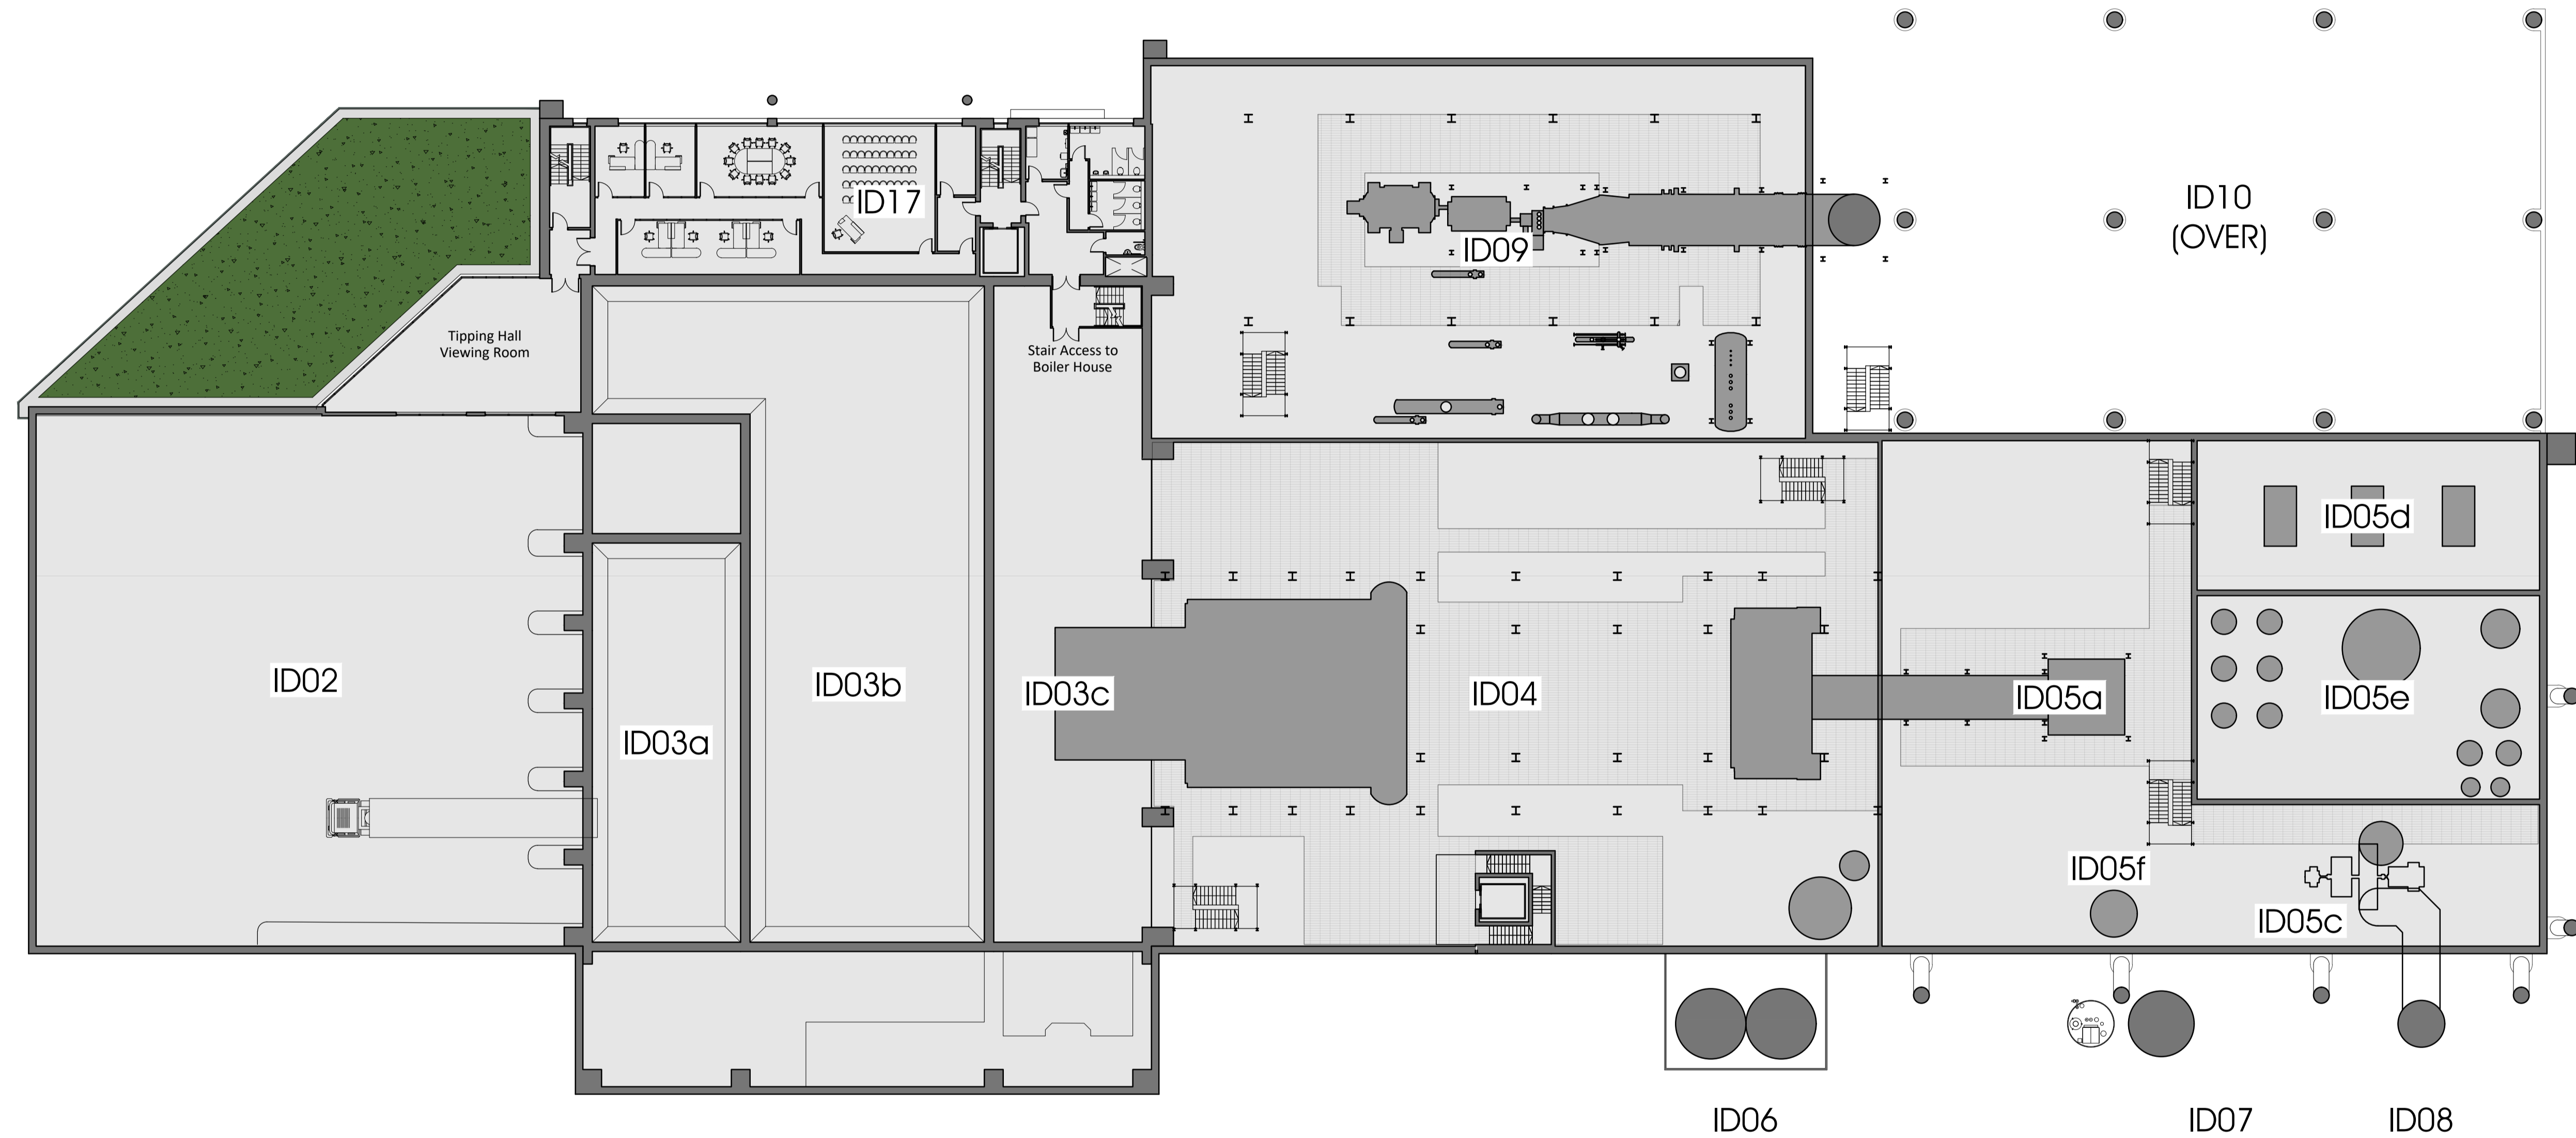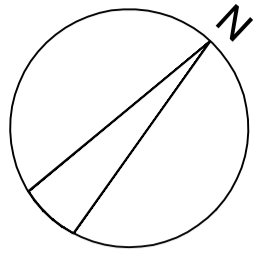


****ID04, ID05, ID09 & ID17 ARRANGEMENT OF INTERNAL EQUIPMENT INDICATIVE ONLY****

PLAN @ FFL 58.200m AOD
 SCALE 1 : 250 @ A1

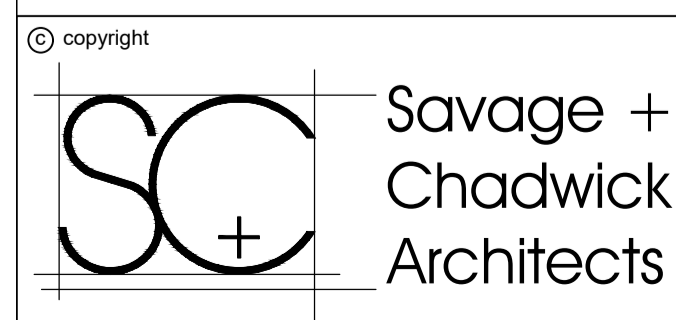

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rev	date	comment

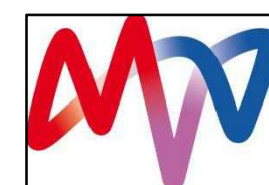client	MVV
project	ENERGY FROM WASTE, COMBINED HEAT & POWER FACILITY, CANFORD.

drawing	PLAN @ FFL 58.200m AOD
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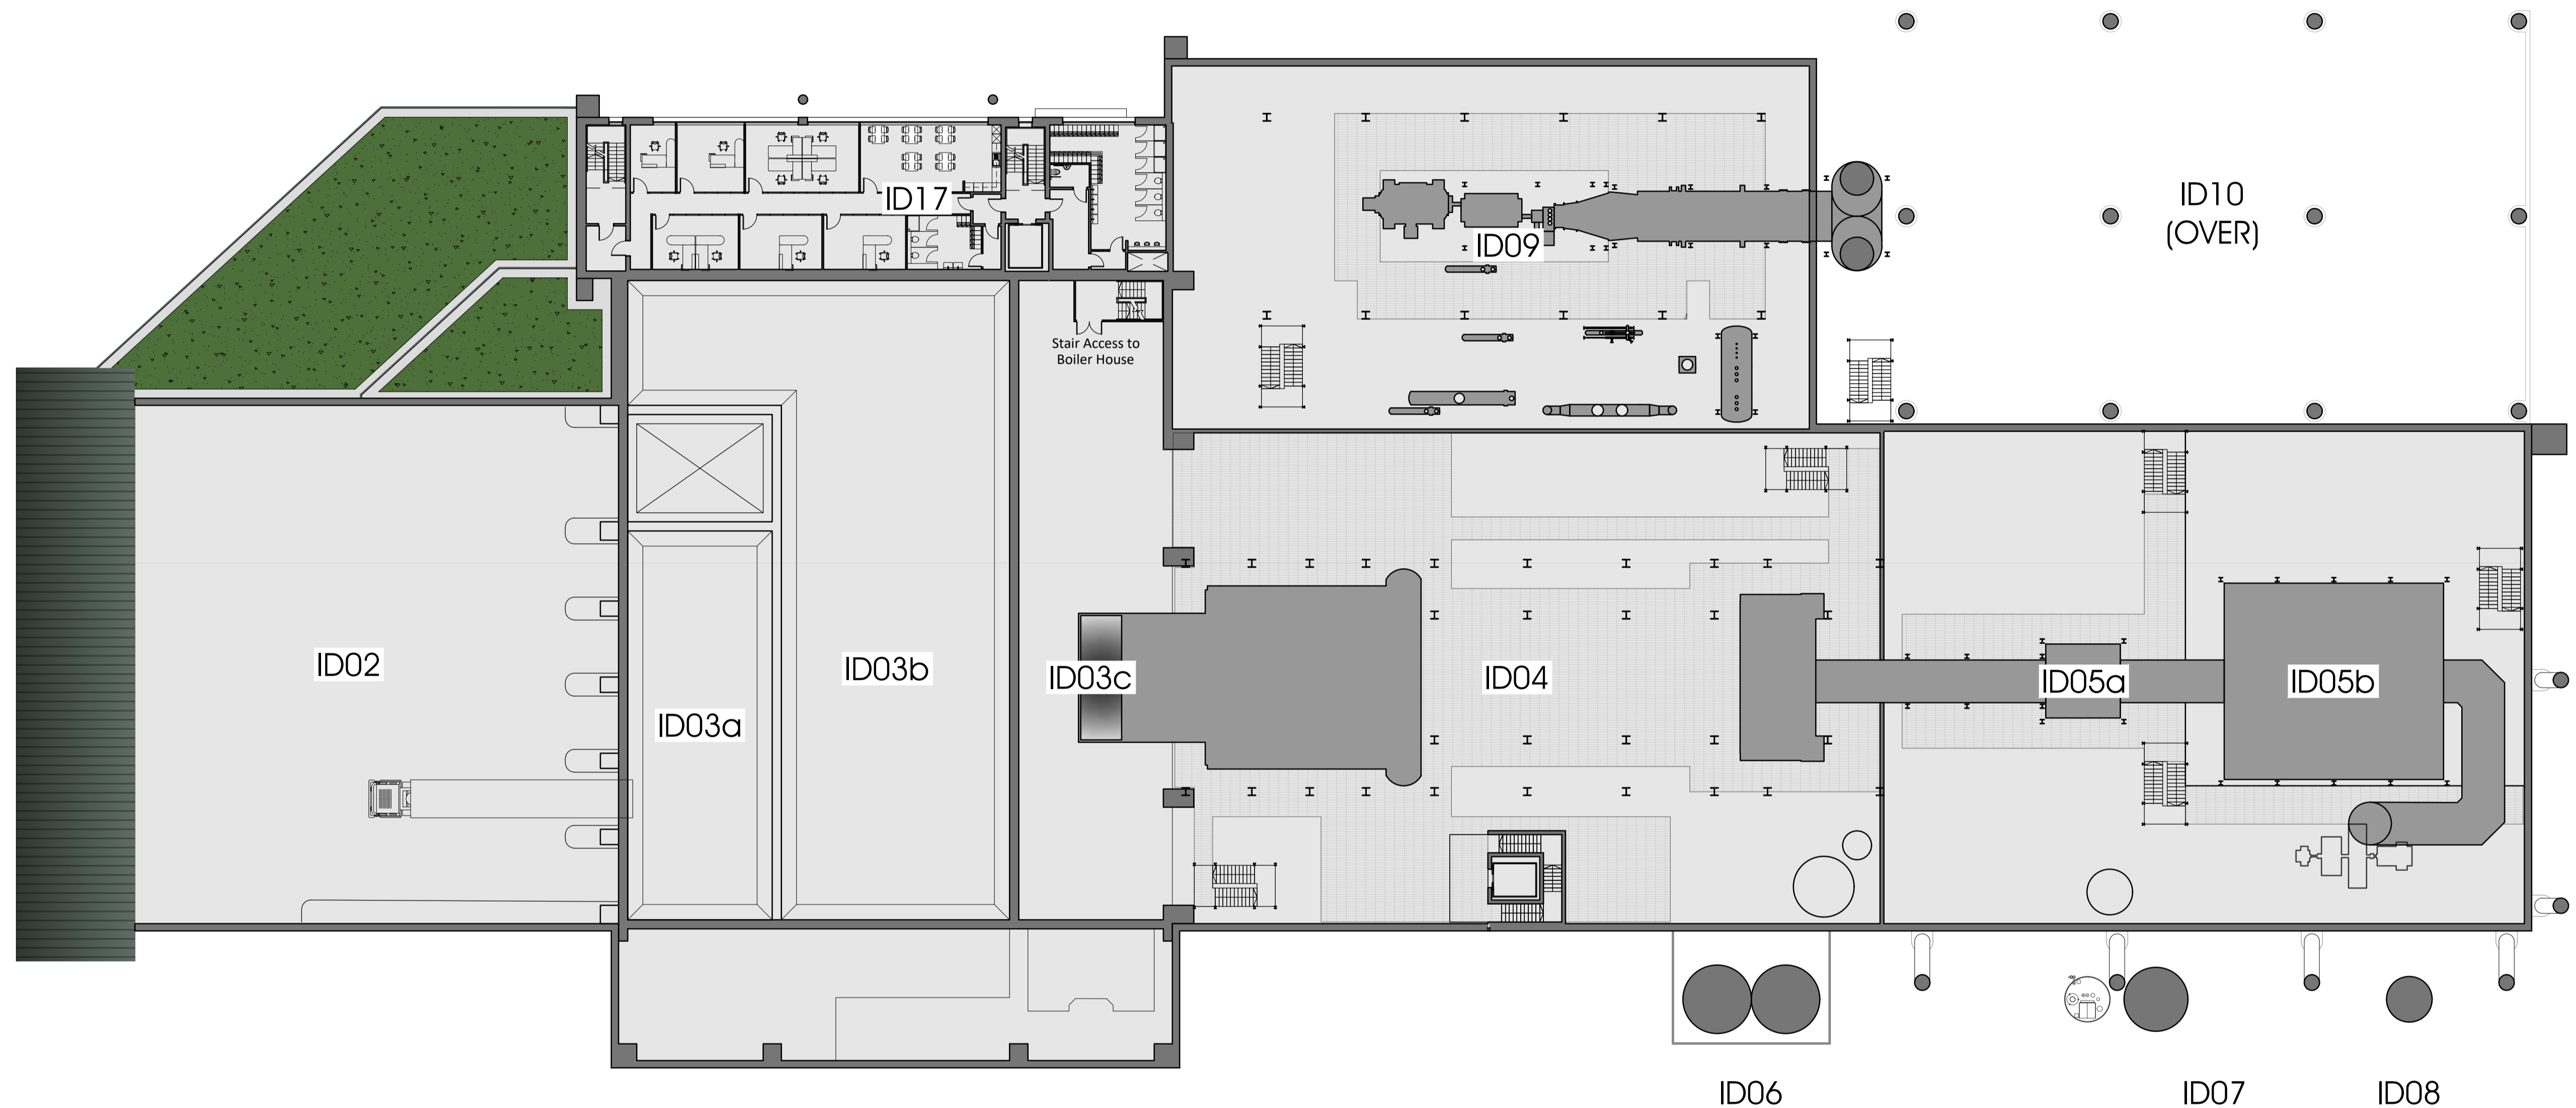
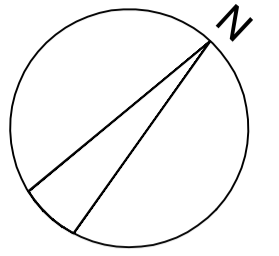
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date	23/02/2023	drawn	NAB
project no.	SC1643/PL	drawing no.	10-05
		rev.	

LEGEND

ID02: Tipping hall
 ID03: Waste bunker building
 (ID03a): Tipping bunker
 (ID03b): Main waste bunker
 (ID03c): Waste chute platform
 (ID03d): Crane maintenance area
 (ID03g): Back loading hatch
 ID04: Boiler house


ID05: Air pollution control building
 (ID05a): APC plant and reactor
 (ID05b): Bag filter house
 (ID05c): Induced draft (ID) fan
 (ID05d): Compressed air station
 (ID05e): Water treatment plant
 (ID05f): Urea tank
 ID06: APCr silos

ID07: Lime & activated carbon silos
 ID08: Chimney & CEMS platform
 ID09: Turbine hall
 ID10: Air cooled condenser (ACC)
 ID17: Switchgear building, administration building and control room




****ID04, ID05, ID09, ID10 & ID17 ARRANGEMENT OF INTERNAL EQUIPMENT INDICATIVE ONLY****

PLAN @ FFL 61.925m AOD
 SCALE 1 : 250 @ A1
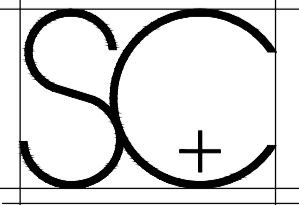
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rev	date	comment

rev	date	comment

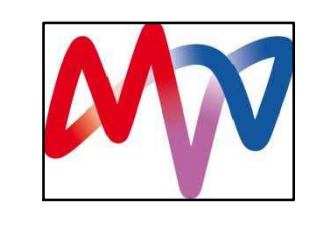client
MVV
 project
ENERGY FROM WASTE, COMBINED HEAT & POWER FACILITY, CANFORD.

drawing
PLAN @ FFL 61.925m AOD



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date	drawn	
23/02/2023	NAB	
project no.	drawing no.	rev.
SC1643/PL	10-06	

LEGEND

ID02: Tipping hall
 ID03: Waste bunker building
 (ID03a): Tipping bunker
 (ID03b): Main waste bunker
 (ID03c): Waste chute platform
 (ID03d): Crane maintenance area
 (ID03g): Back loading hatch
 ID04: Boiler house


ID05: Air pollution control building
 (ID05a): APC plant and reactor
 (ID05b): Bag filter house
 (ID05c): Induced draft (ID) fan
 (ID05d): Compressed air station
 (ID05e): Water treatment plant
 (ID05f): Urea tank
 ID06: APCr silos

ID07: Lime & activated carbon silos
 ID08: Chimney & CEMS platform
 ID09: Turbine hall
 ID10: Air cooled condenser (ACC)
 ID17: Switchgear building, administration building and control room

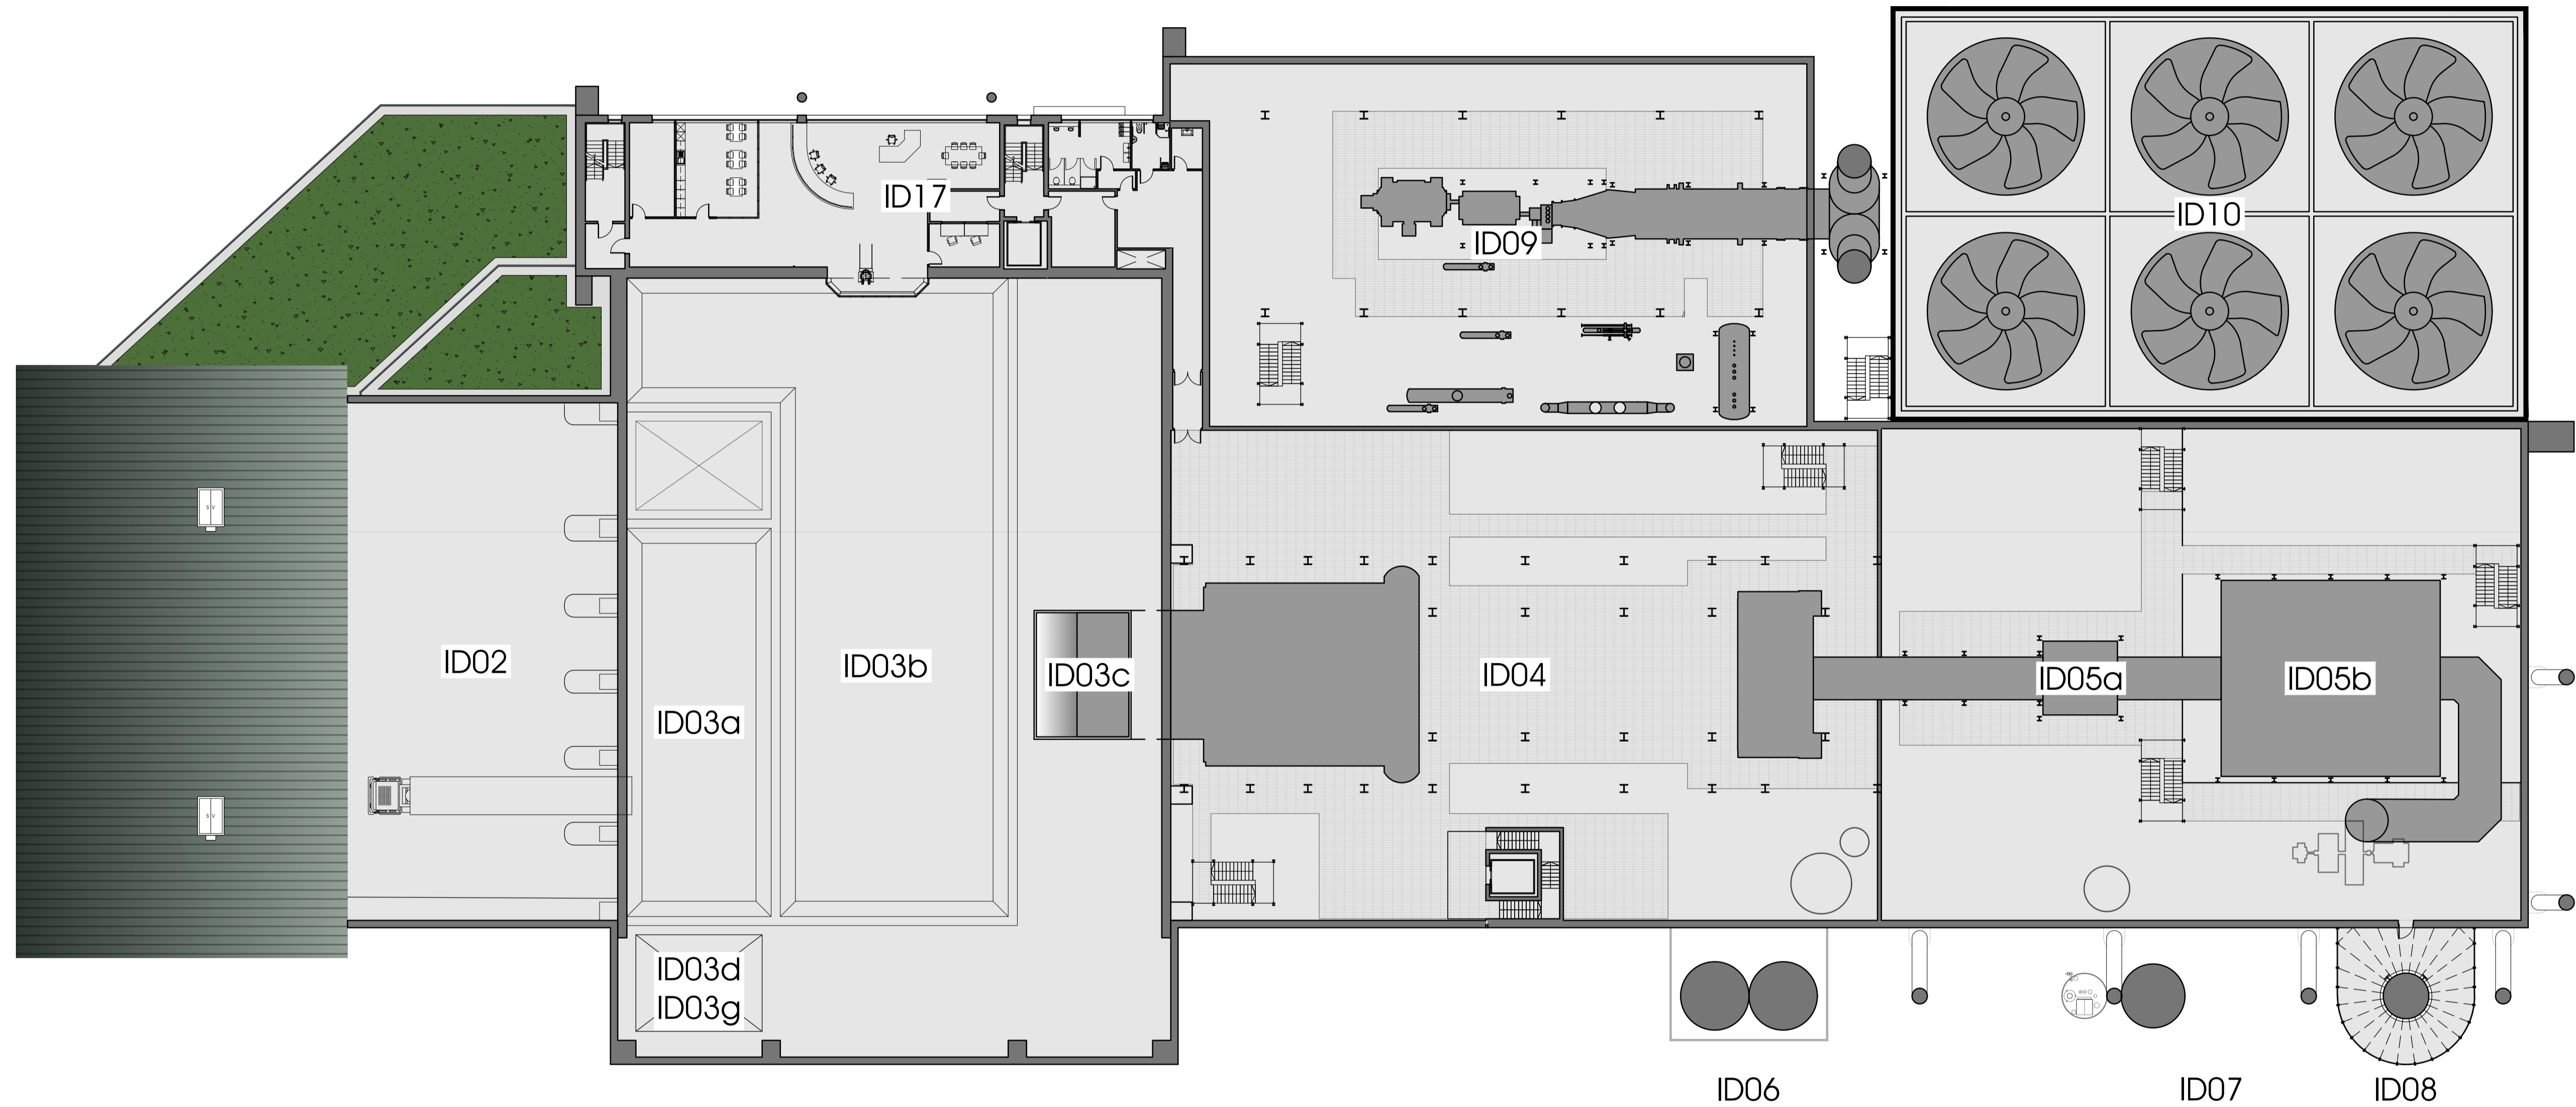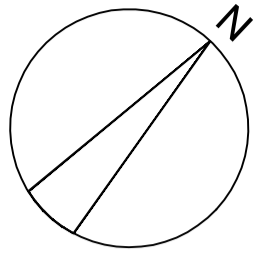


****ID04, ID05, ID09, ID10 & ID17 ARRANGEMENT OF INTERNAL EQUIPMENT INDICATIVE ONLY****

PLAN @ FFL 67.650m AOD
 SCALE 1 : 250 @ A1

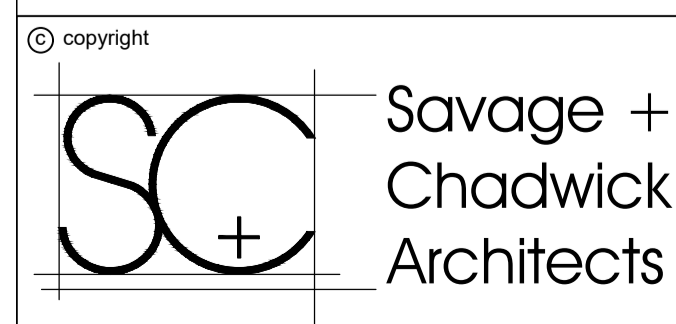

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rev	date	comment

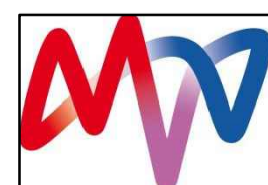client
 MVV
 project
 ENERGY FROM WASTE,
 COMBINED HEAT & POWER
 FACILITY, CANFORD.

drawing
 PLAN @ FFL 67.650m AOD
 scale
 1:250
 date
 23/02/2023
 project no.
 SC1643/PL

paper size	scale	date	project no.	drawing no.	rev.
A1	1:250	23/02/2023	SC1643/PL	10-07	



rev	date	comment

LEGEND

ID02: Tipping hall
 ID03: Waste bunker building
 (ID03a): Tipping bunker
 (ID03b): Main waste bunker
 (ID03c): Waste chute platform
 ID04: Boiler house


ID05: Air pollution control building
 (ID05a): APC plant and reactor
 (ID05b): Bag filter house
 (ID05c): Induced draft (ID) fan
 (ID05d): Compressed air station
 (ID05e): Water treatment plant
 (ID05f): Urea tank

ID06: APCr silos
 ID07: Lime & activated carbon silos
 ID08: Chimney & CEMS platform
 ID10: Air cooled condenser (ACC)
 ID11: Water re-cooling system
 ID17: Switchgear building, administration building and control room

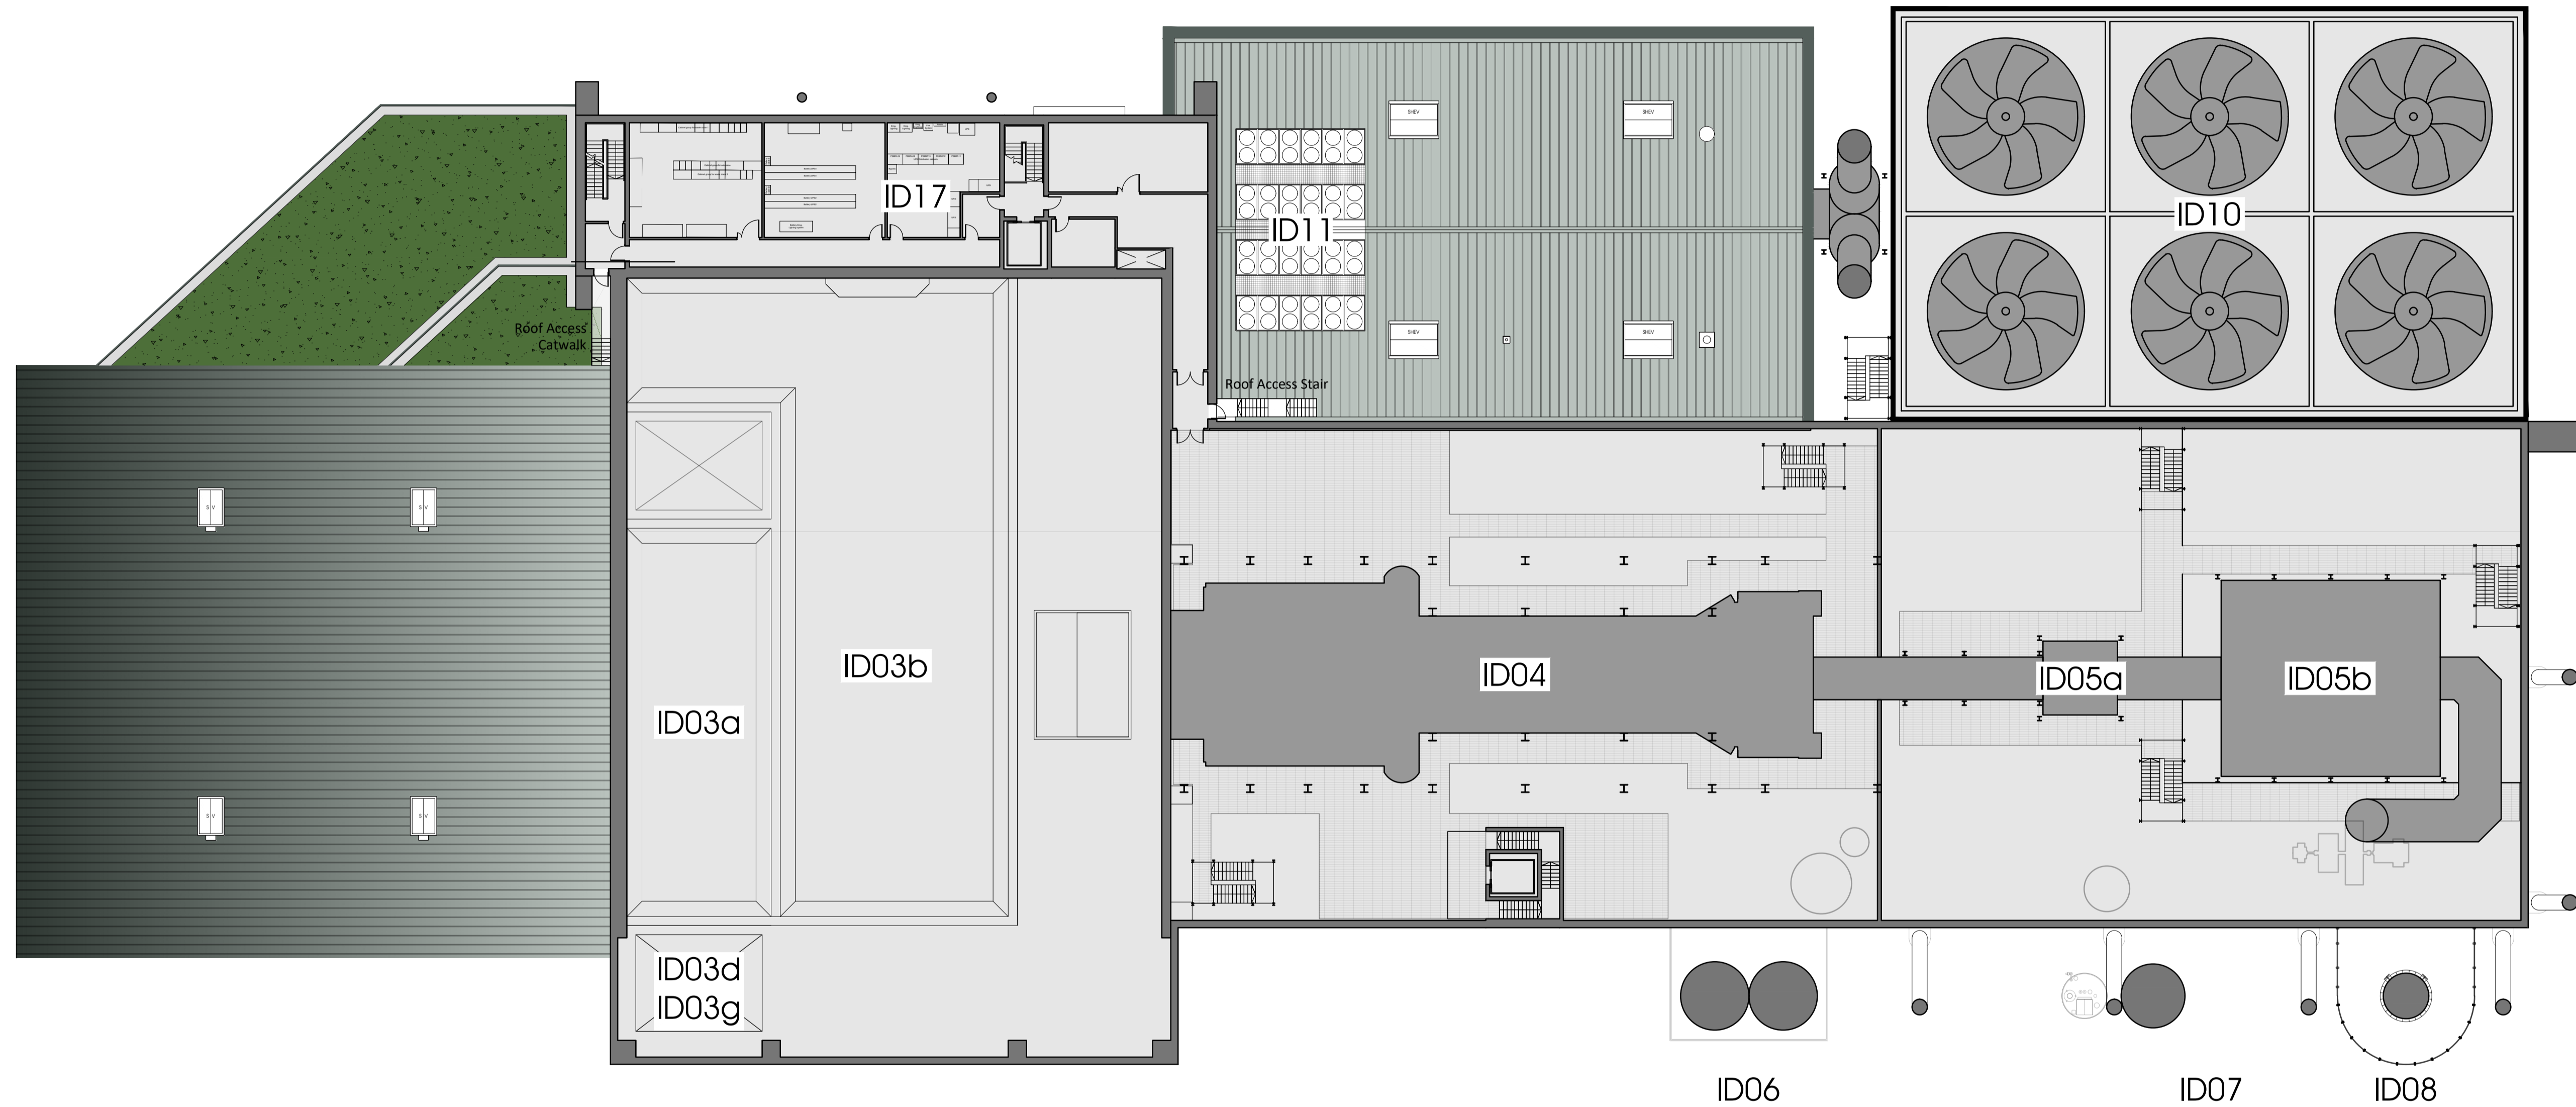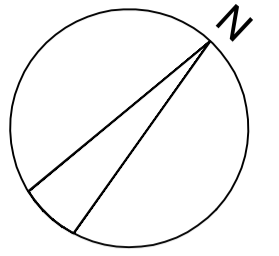


****ID04, ID05, ID10 & ID17 ARRANGEMENT OF INTERNAL EQUIPMENT INDICATIVE ONLY****

PLAN @ FFL 71.375m AOD
 SCALE 1 : 250 @ A1

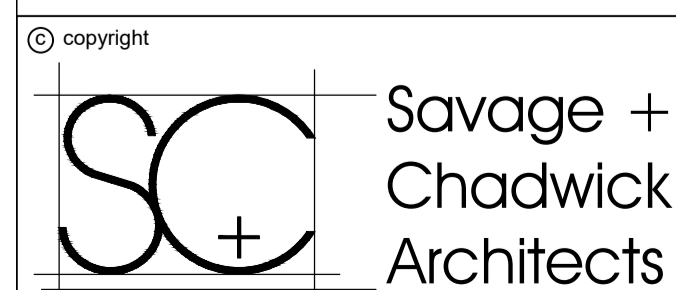

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rev date comment

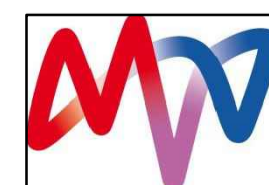
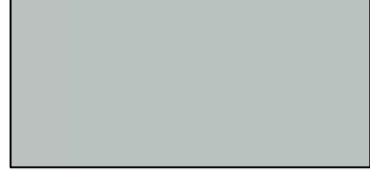
rev date comment

client
 MVV
 project
 ENERGY FROM WASTE,
 COMBINED HEAT & POWER
 FACILITY, CANFORD.

drawing
 PLAN @ FFL 71.375m AOD



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project no.	SC1643/PL	drawing no.	10-08
		rev.	

KEY


- A Low pitch, trapezoidal, insulated roof panel Kingspan KS1000RW or equivalent.
in Goosewing Grey 
- B Curved, trapezoidal, insulated roof panel Kingspan KS1000RW or equivalent.
in Goosewing Grey 
- C Sedum/green flat roof

LEGEND

- ID06: APCr silos
- ID08: Chimney & CEMS platform
- ID10: Air cooled condenser (ACC)
- ID11: Water re-cooling system

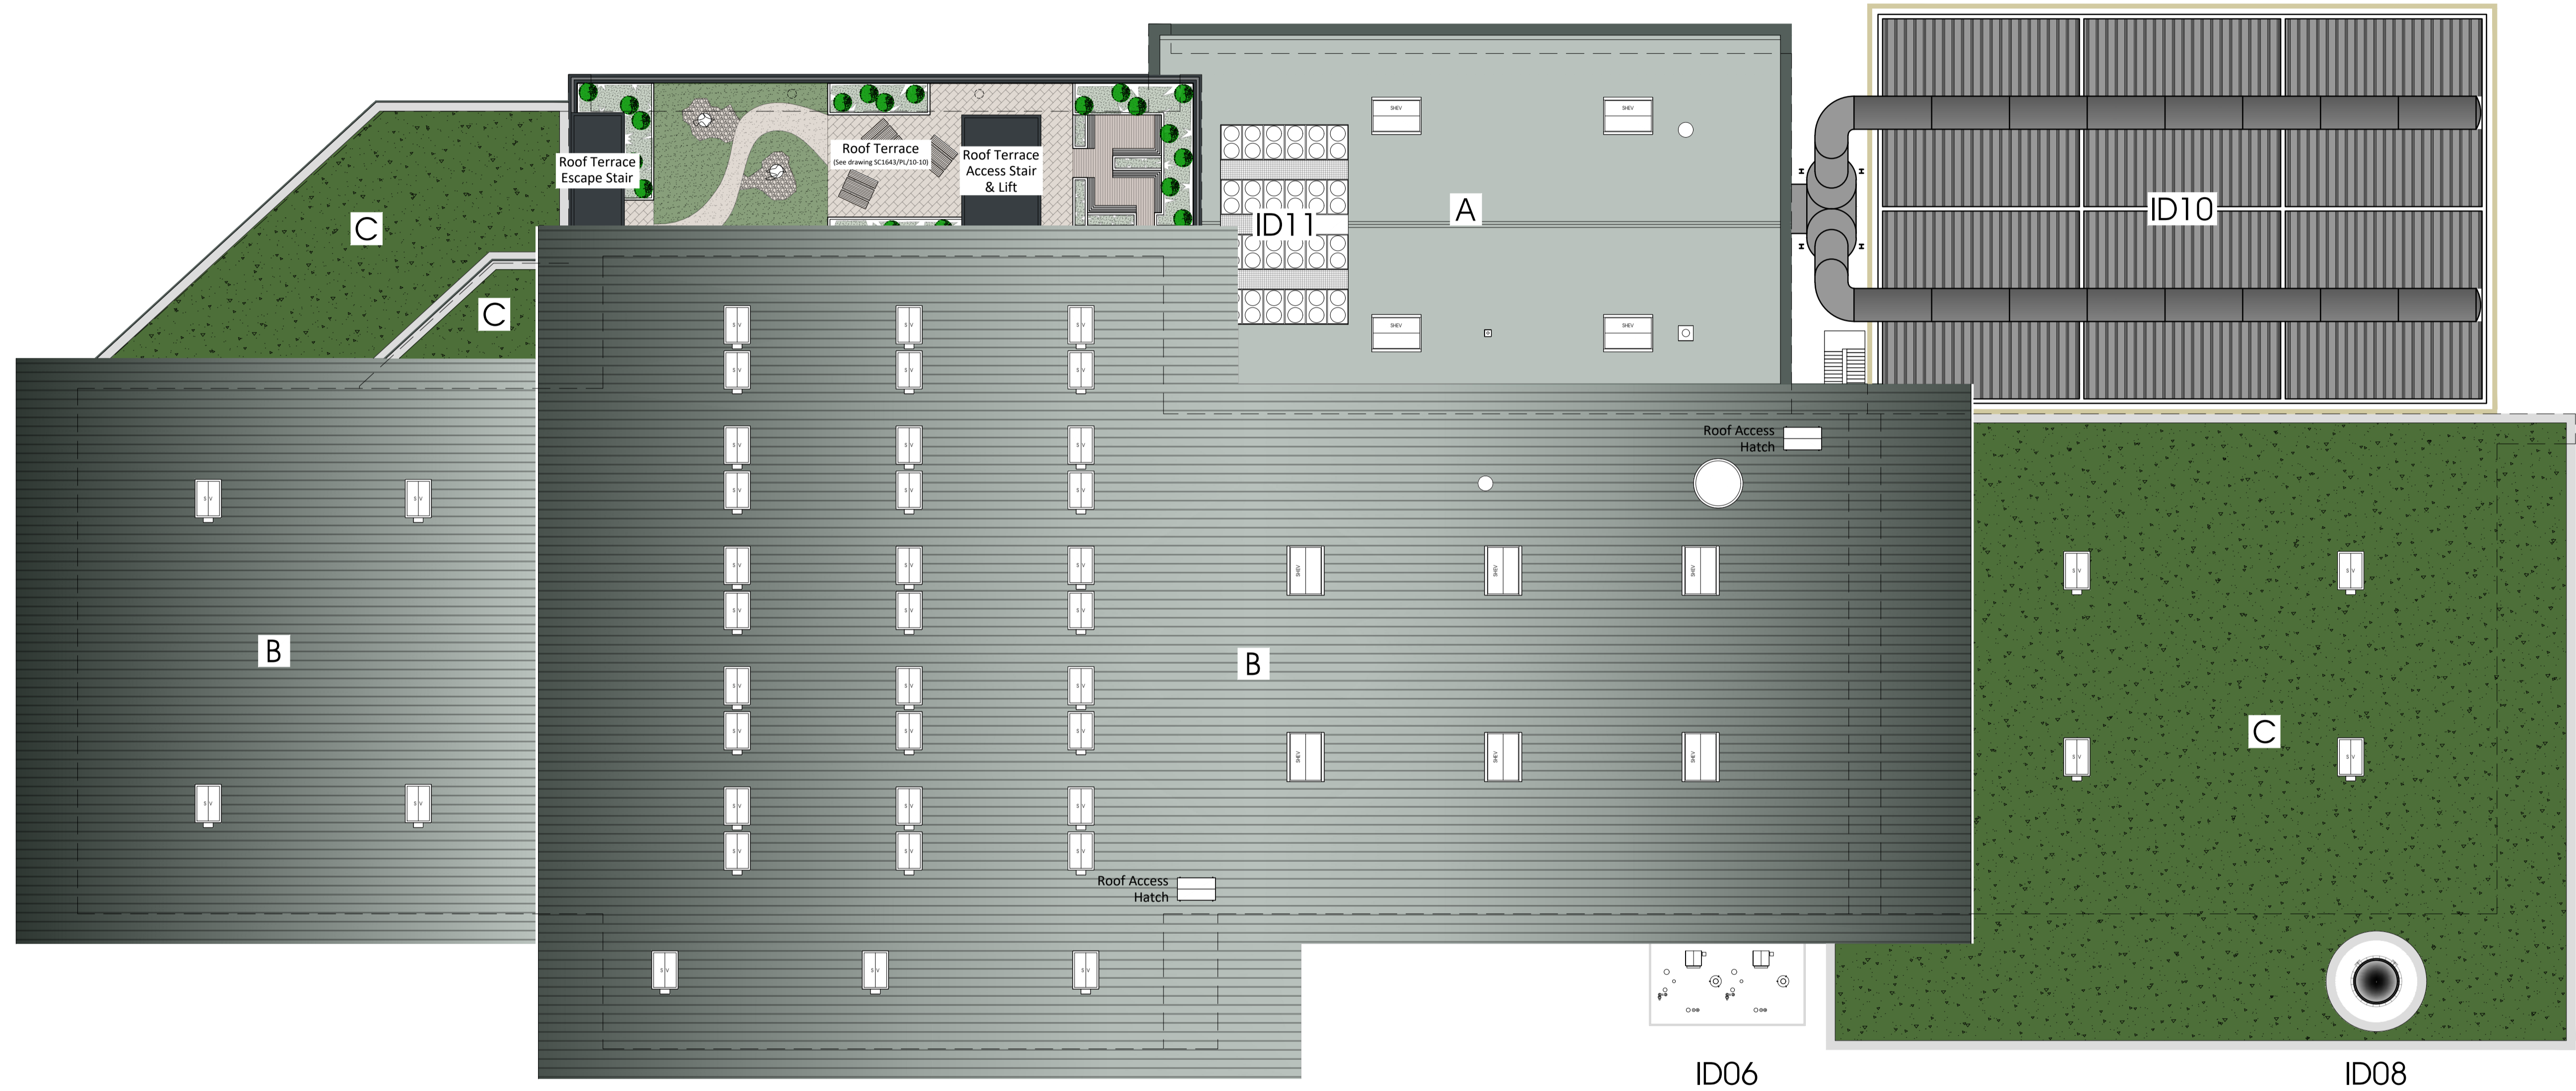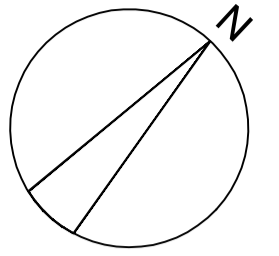


ROOF PLAN
SCALE 1 : 250 @ A1

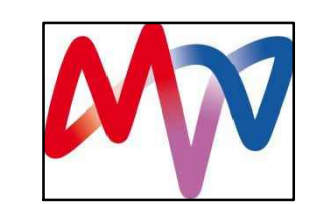





rev	date	comment


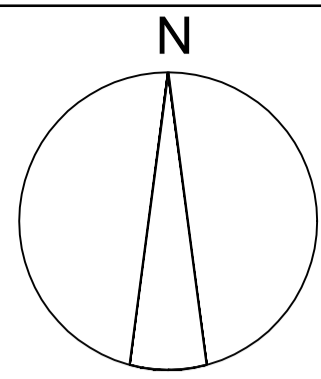
rev	date	comment




0m 2.5m 5m 7.5m 10m

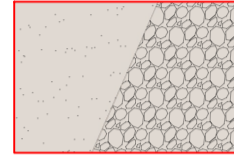-  Paving slabs
-  Non-slip, timber effect aluminium decking
-  Informal gravel pathway
-  Sedum lawn


Final planting scheme to be confirmed by landscape architect

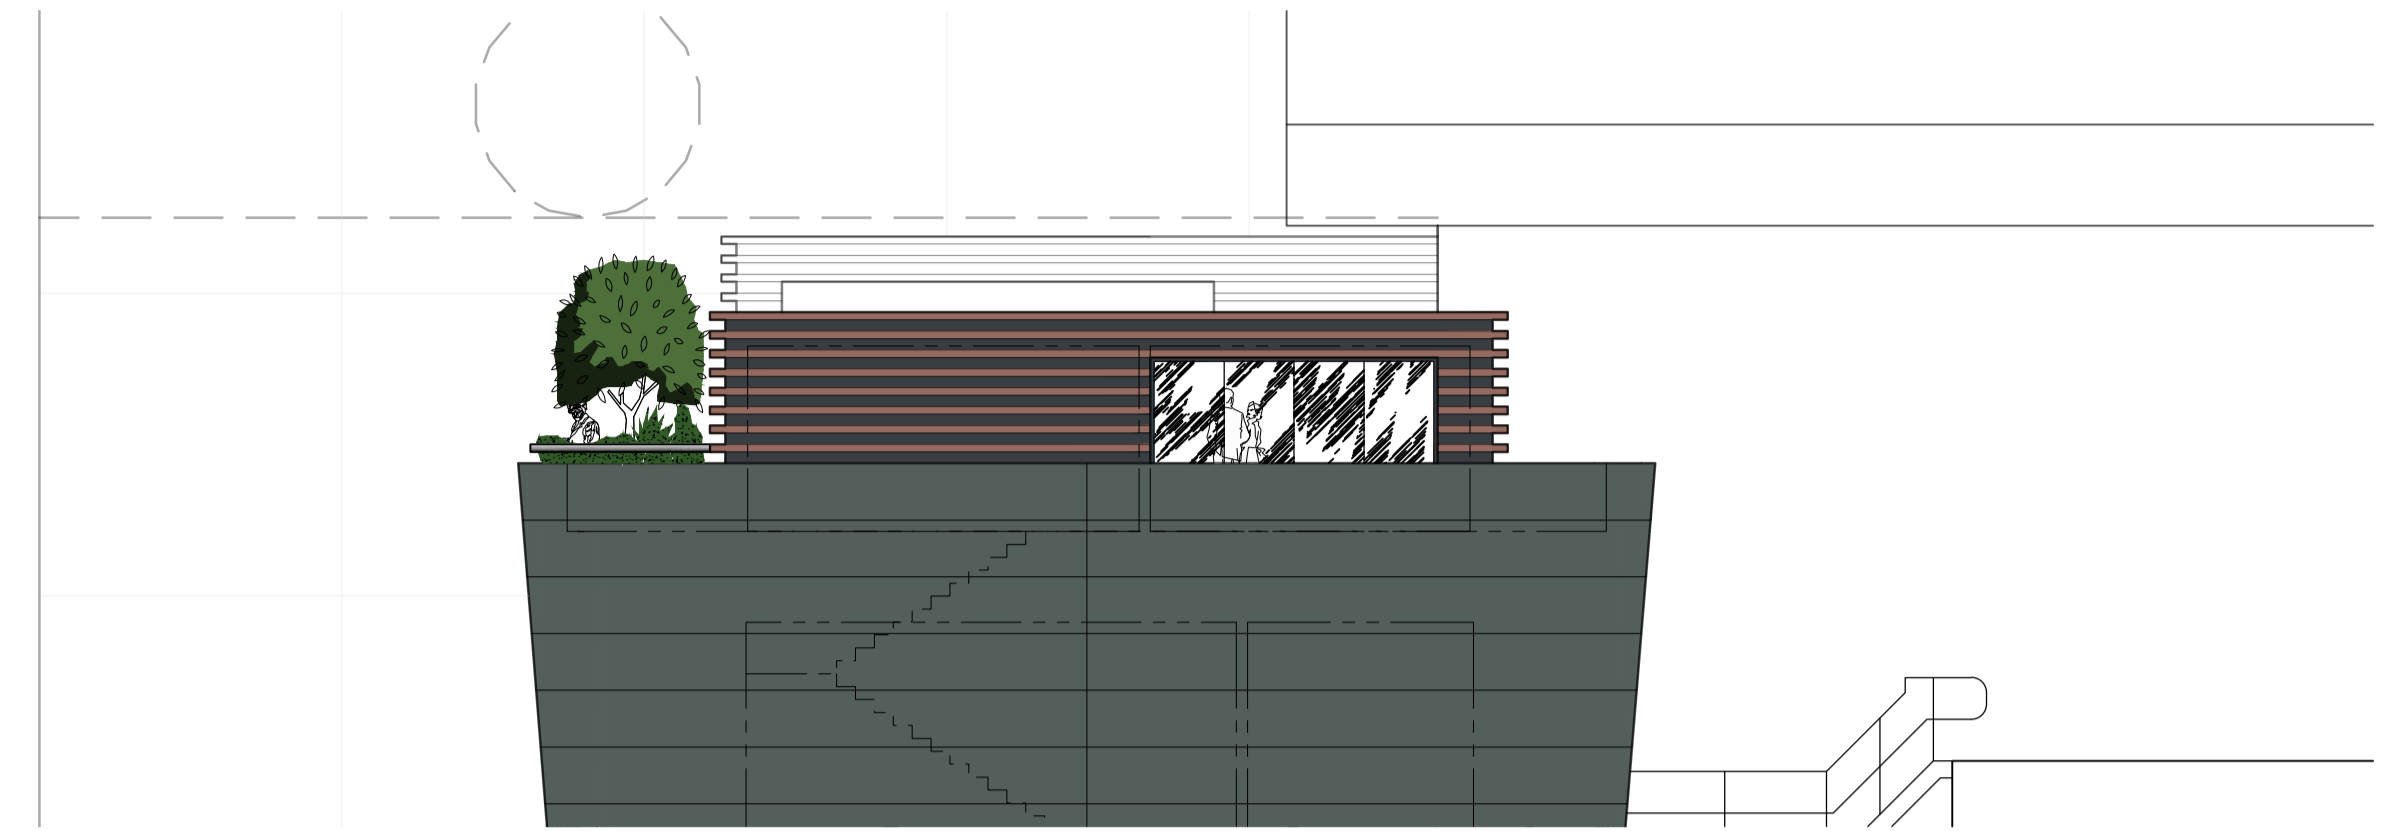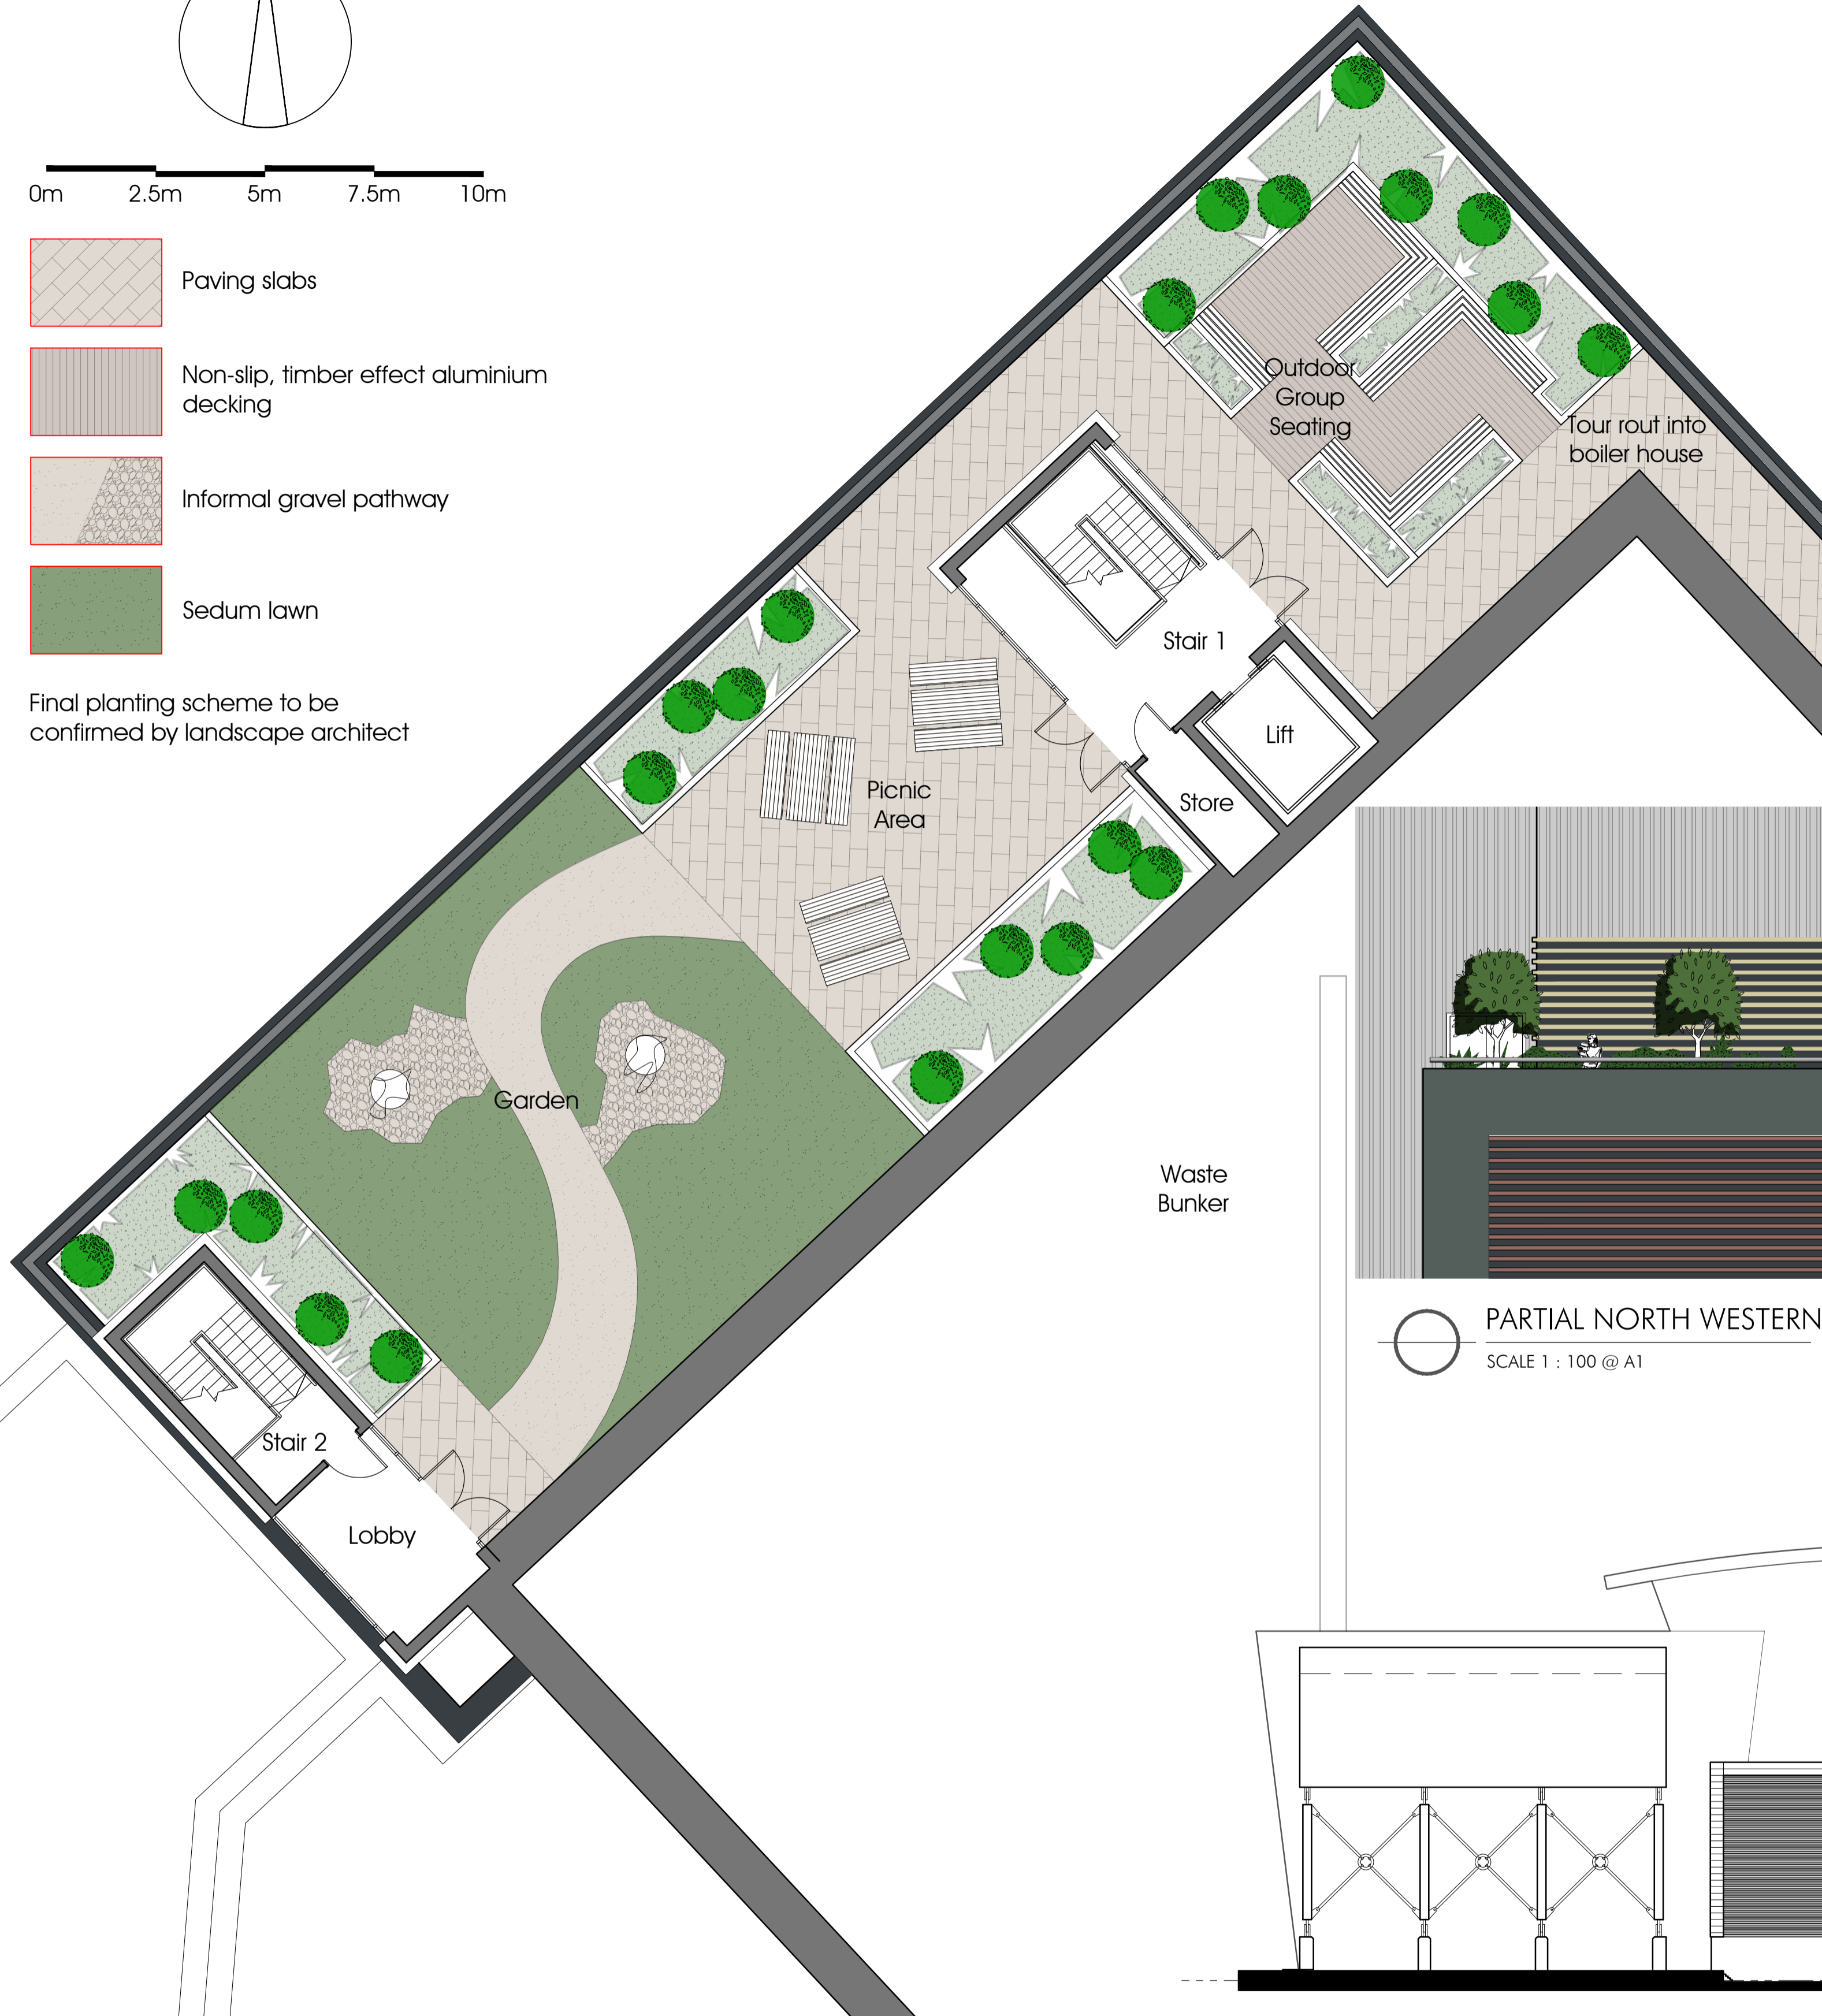


 PARTIAL SOUTH WESTERN ELEVATION
SCALE 1 : 100 @ A1

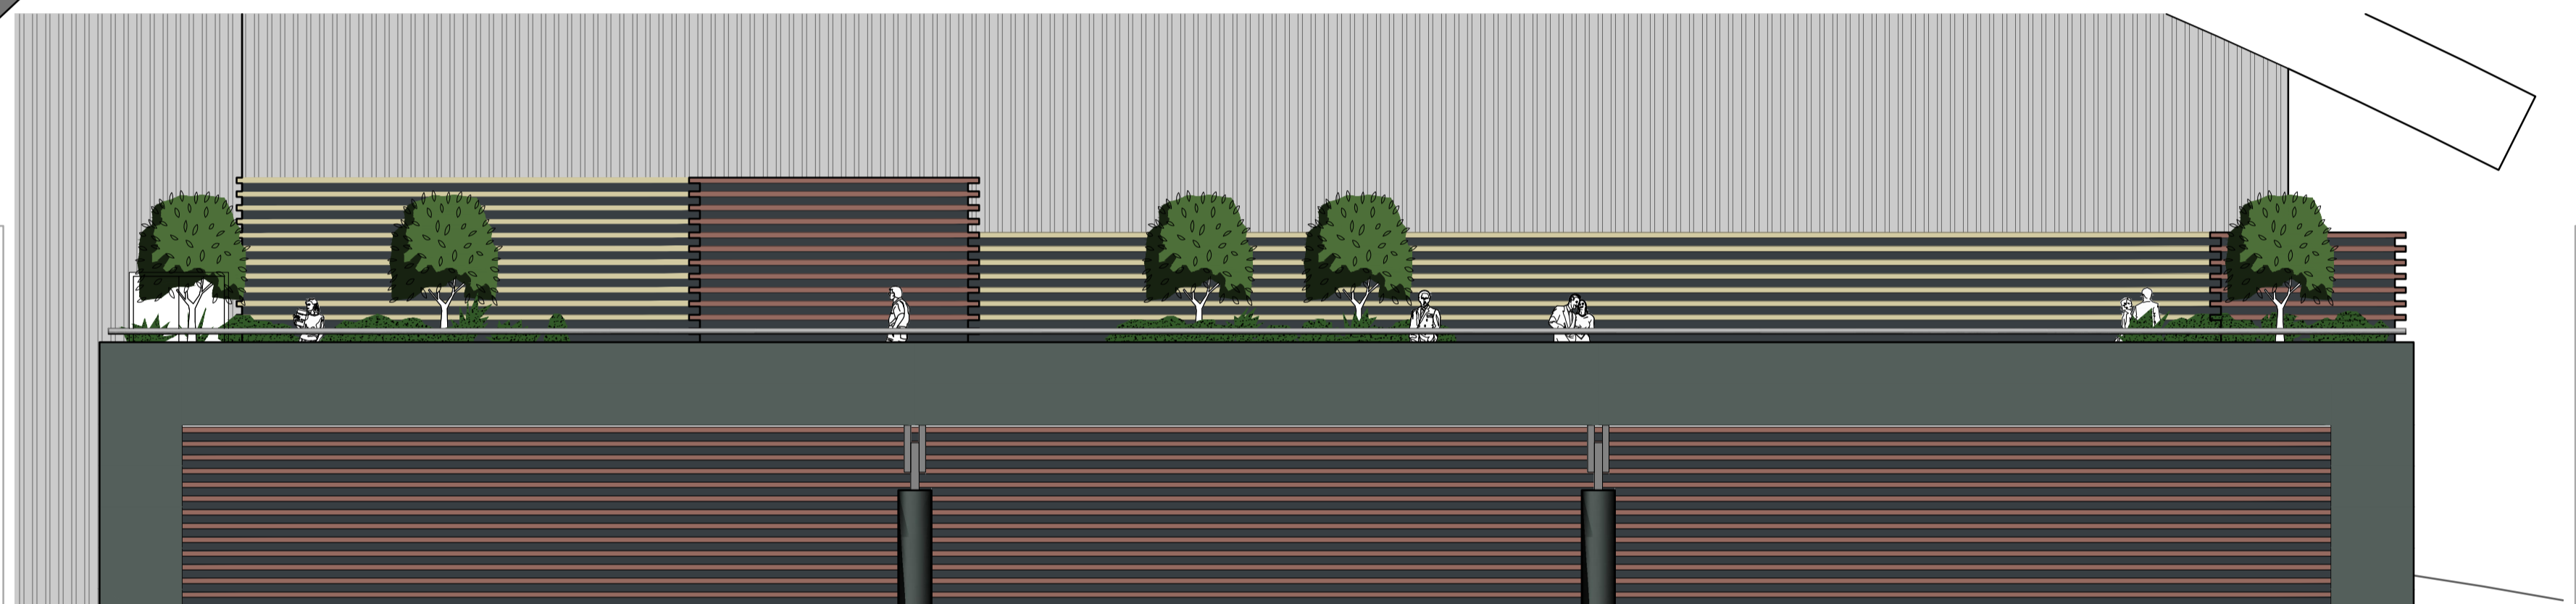

 PARTIAL NORTH WESTERN ELEVATION
SCALE 1 : 100 @ A1

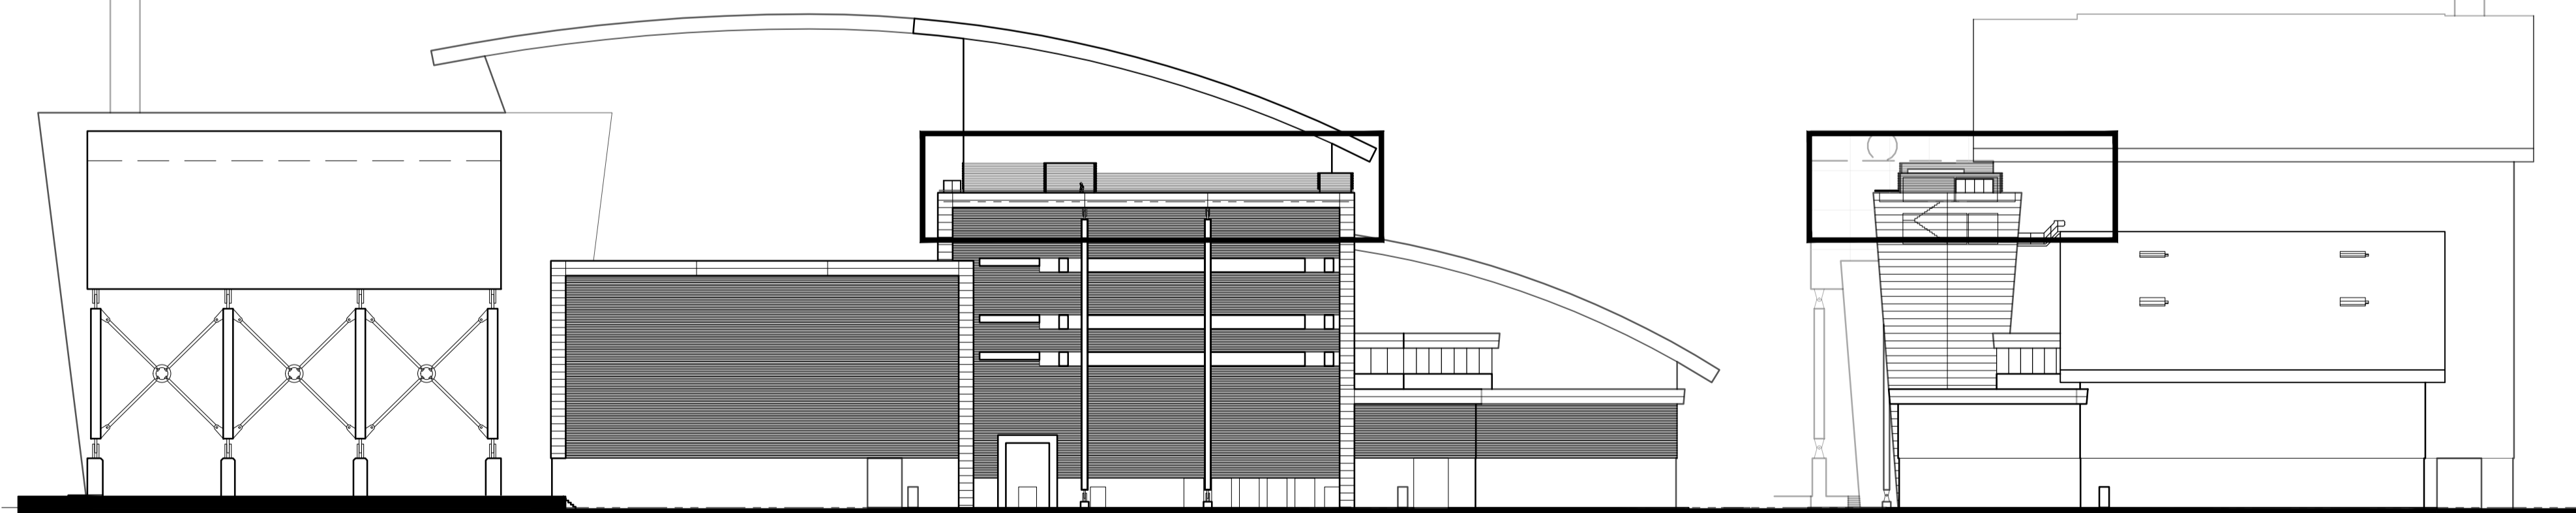

 NORTH WESTERN ELEVATION
SCALE 1 : 500 @ A1

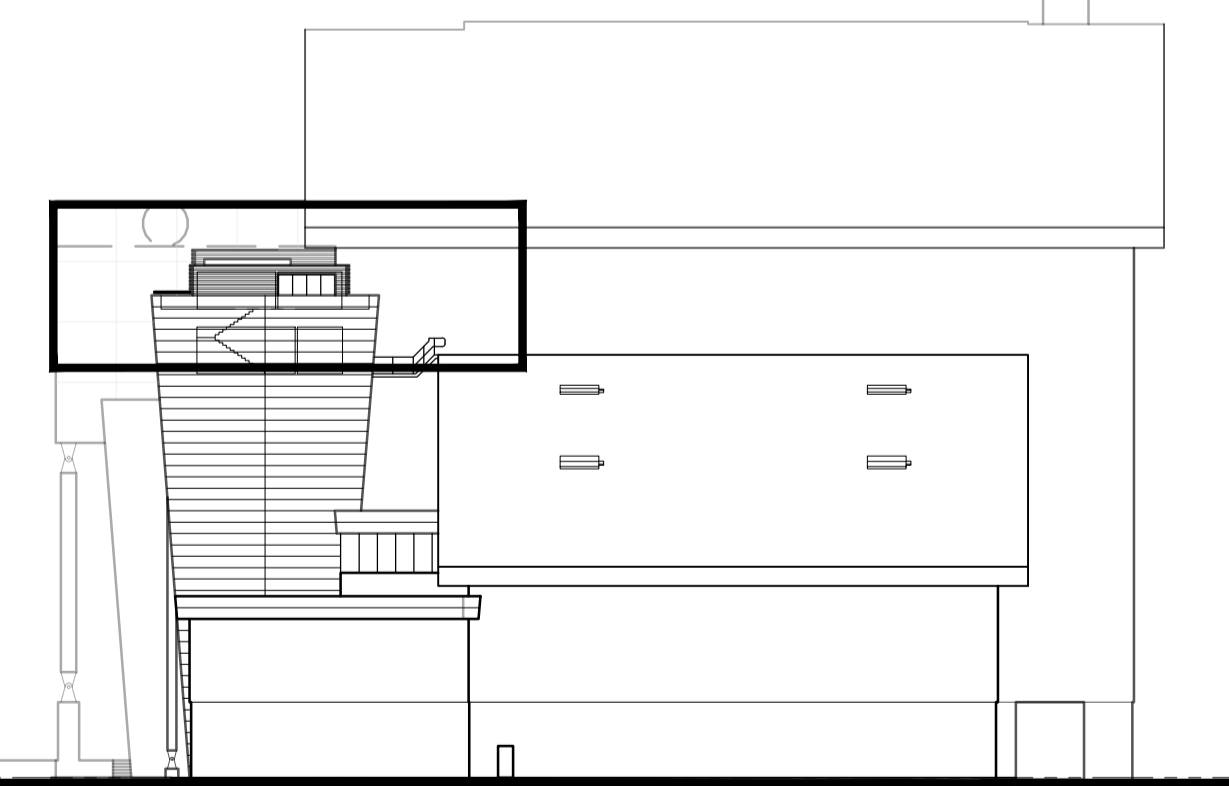

 SOUTH WESTERN ELEVATION
SCALE 1 : 500 @ A1

 ROOF TERRACE PLAN
SCALE 1 : 100 @ A1